




1 ALTERNATE #1 - THIRD FLOOR - PLUMBING DEMOLITION
PL-1 1/8" = 1'-0"

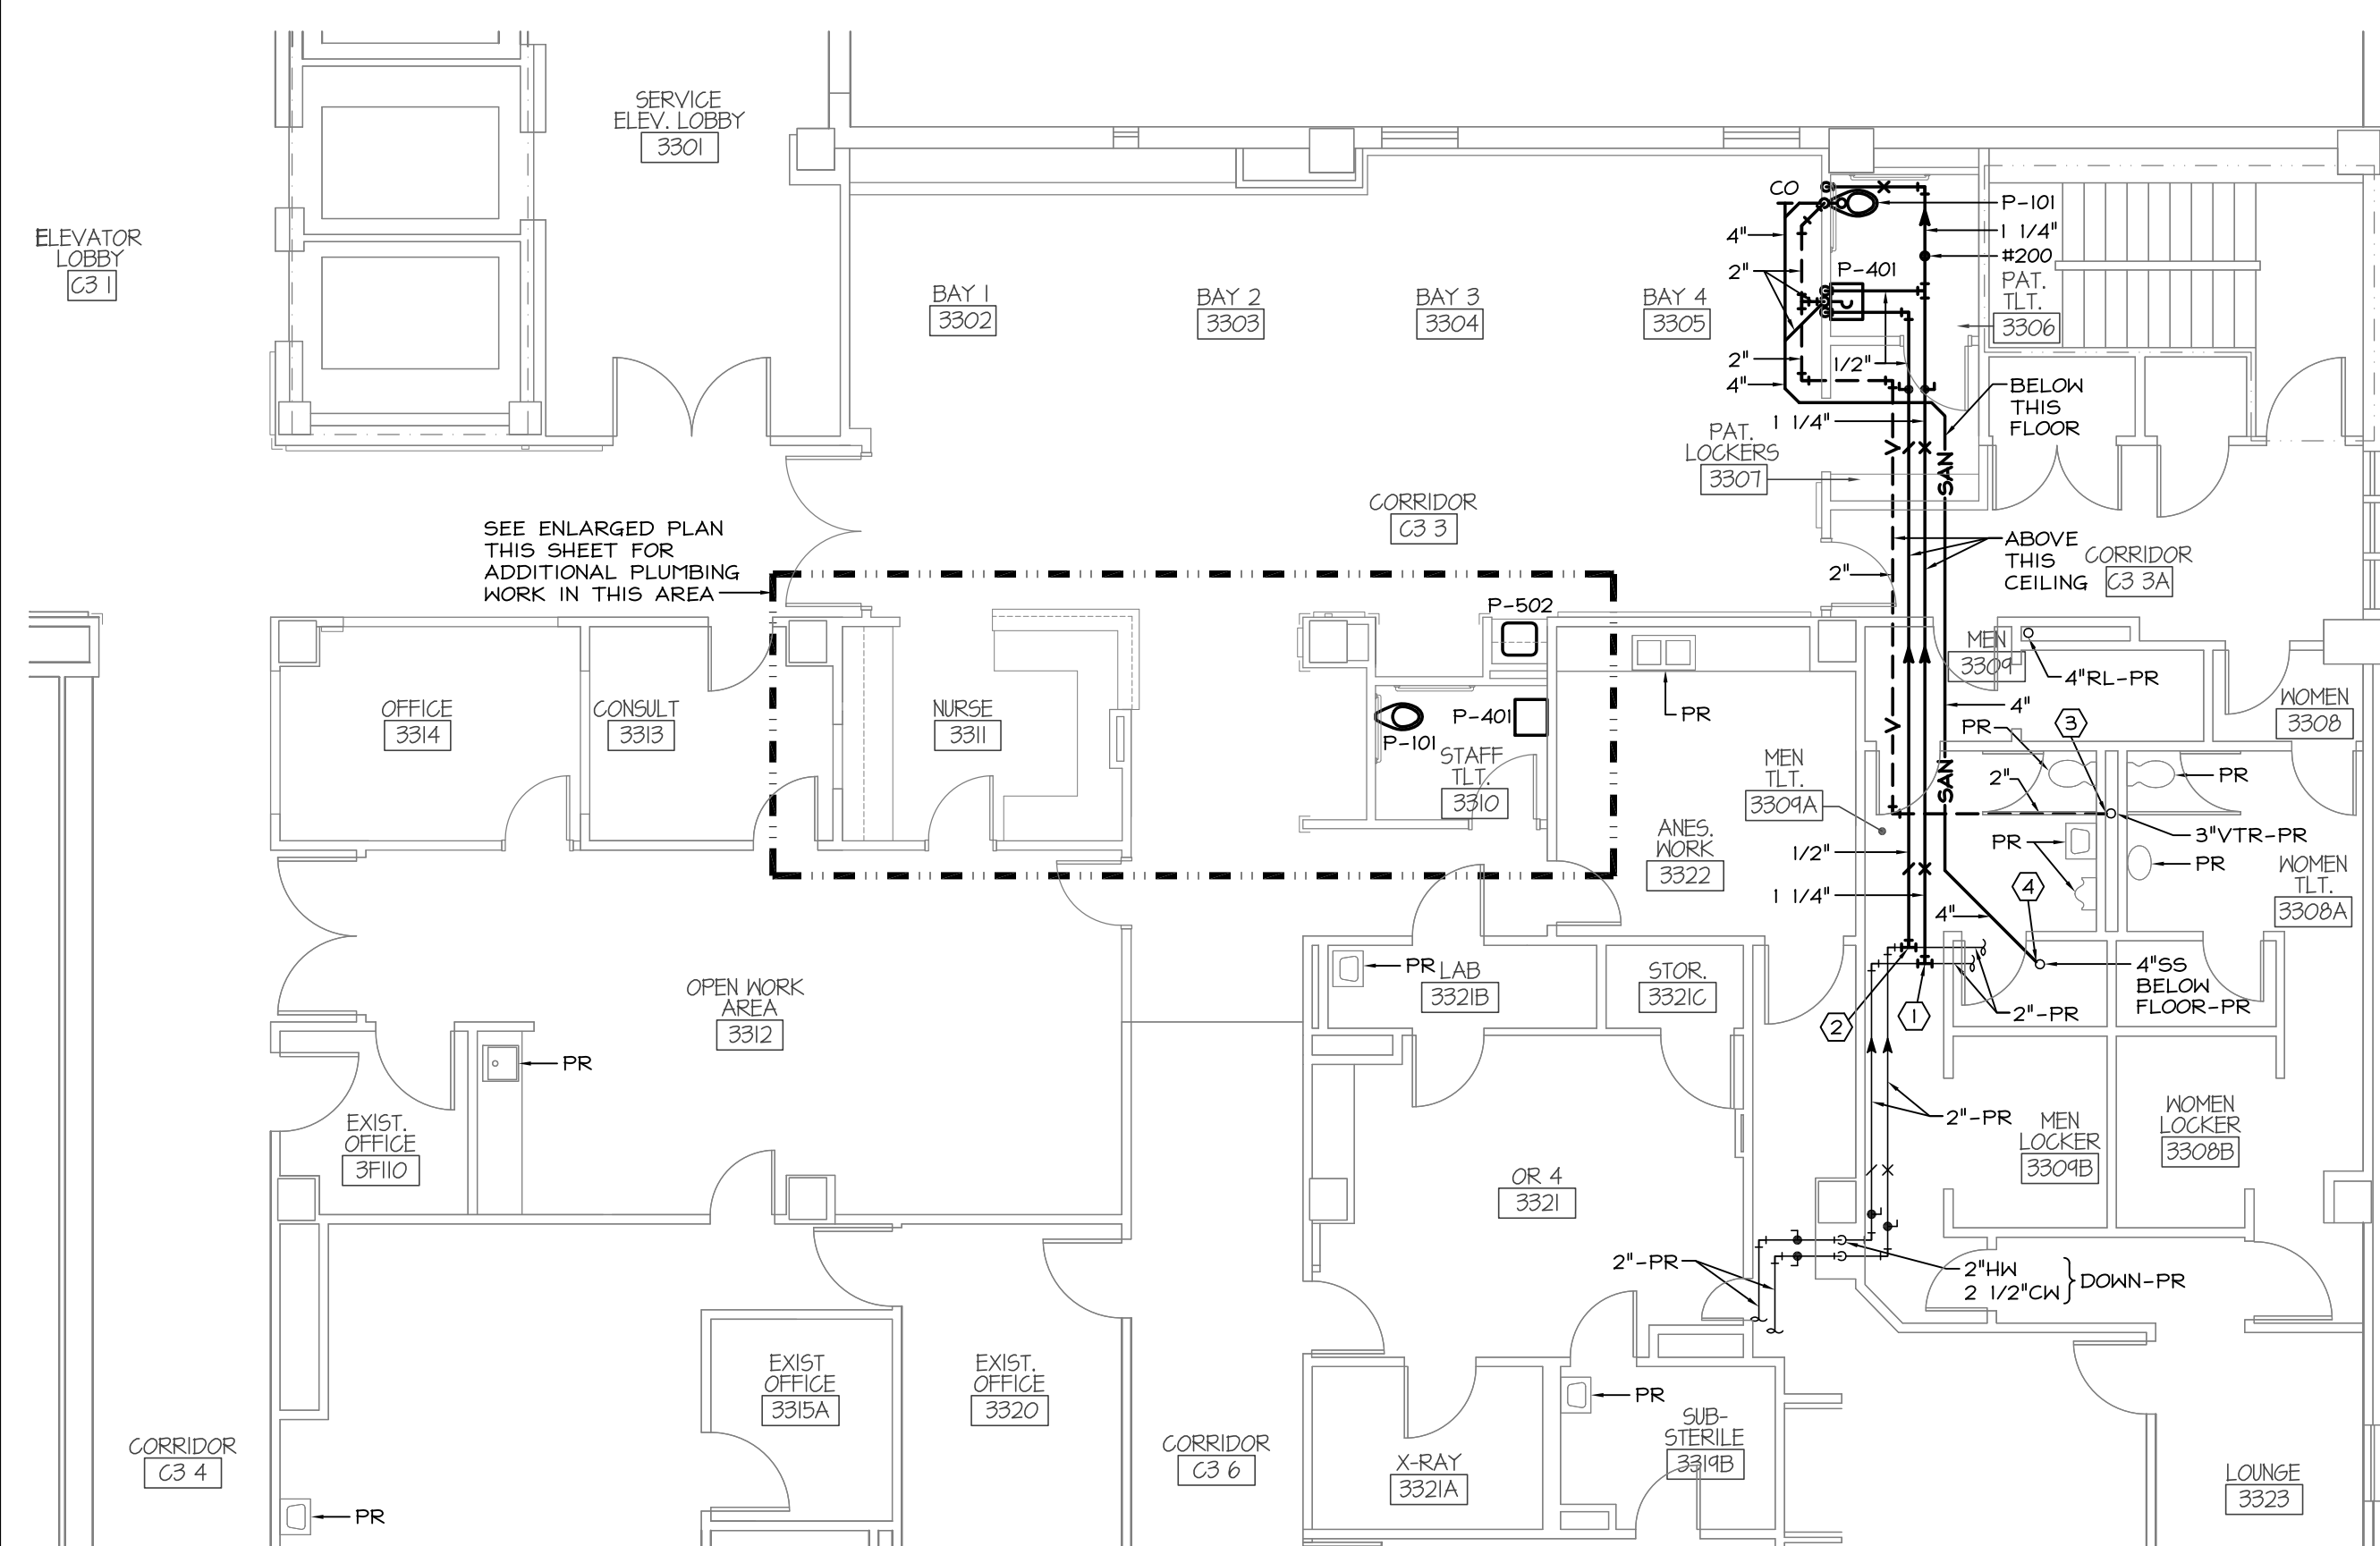

2 ALTERNATE #1 - THIRD FLOOR - PLUMBING NEW WORK
PL-1 1/8" = 1'-0"

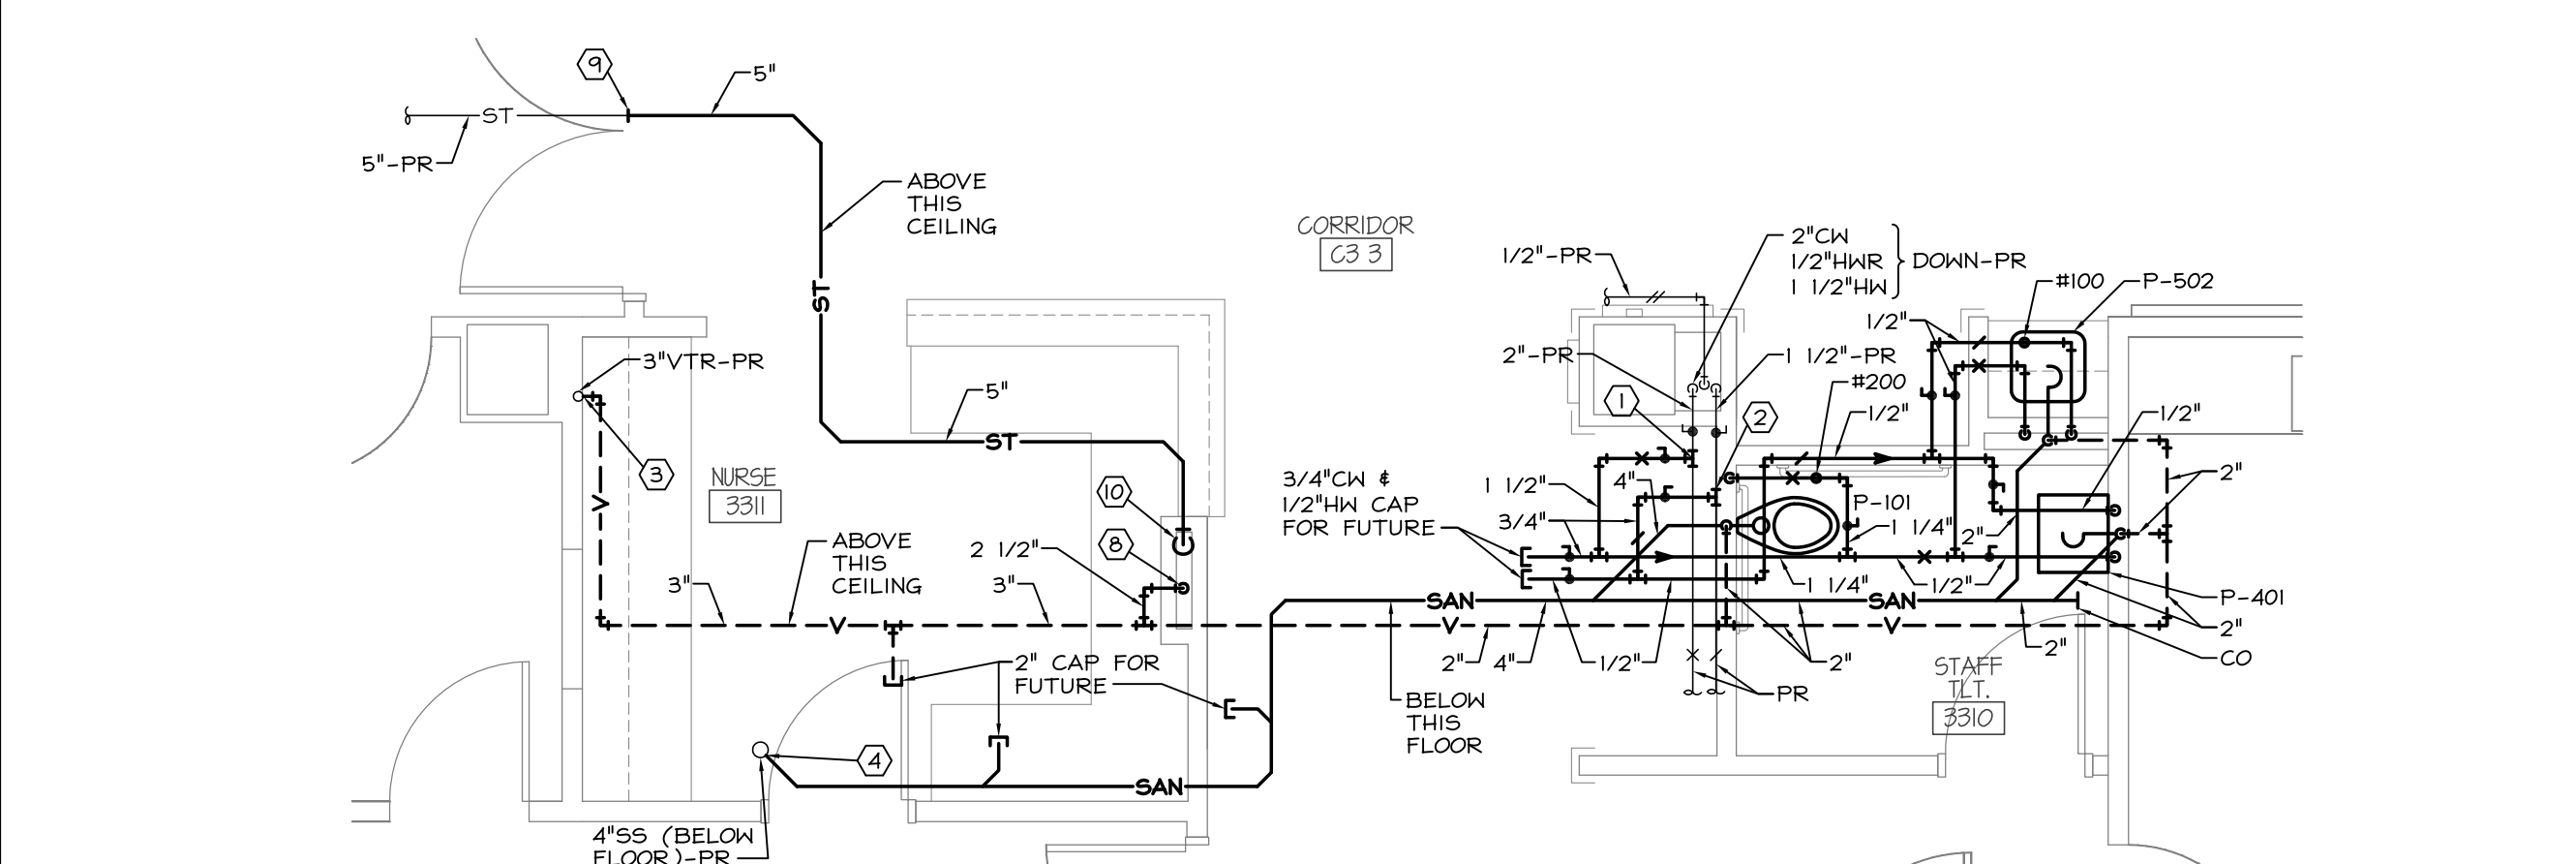

3 ALTERNATE #1 - ENLARGED PARTIAL THIRD FLOOR - PLUMBING NEW WORK
PL-1 1/4" = 1'-0"

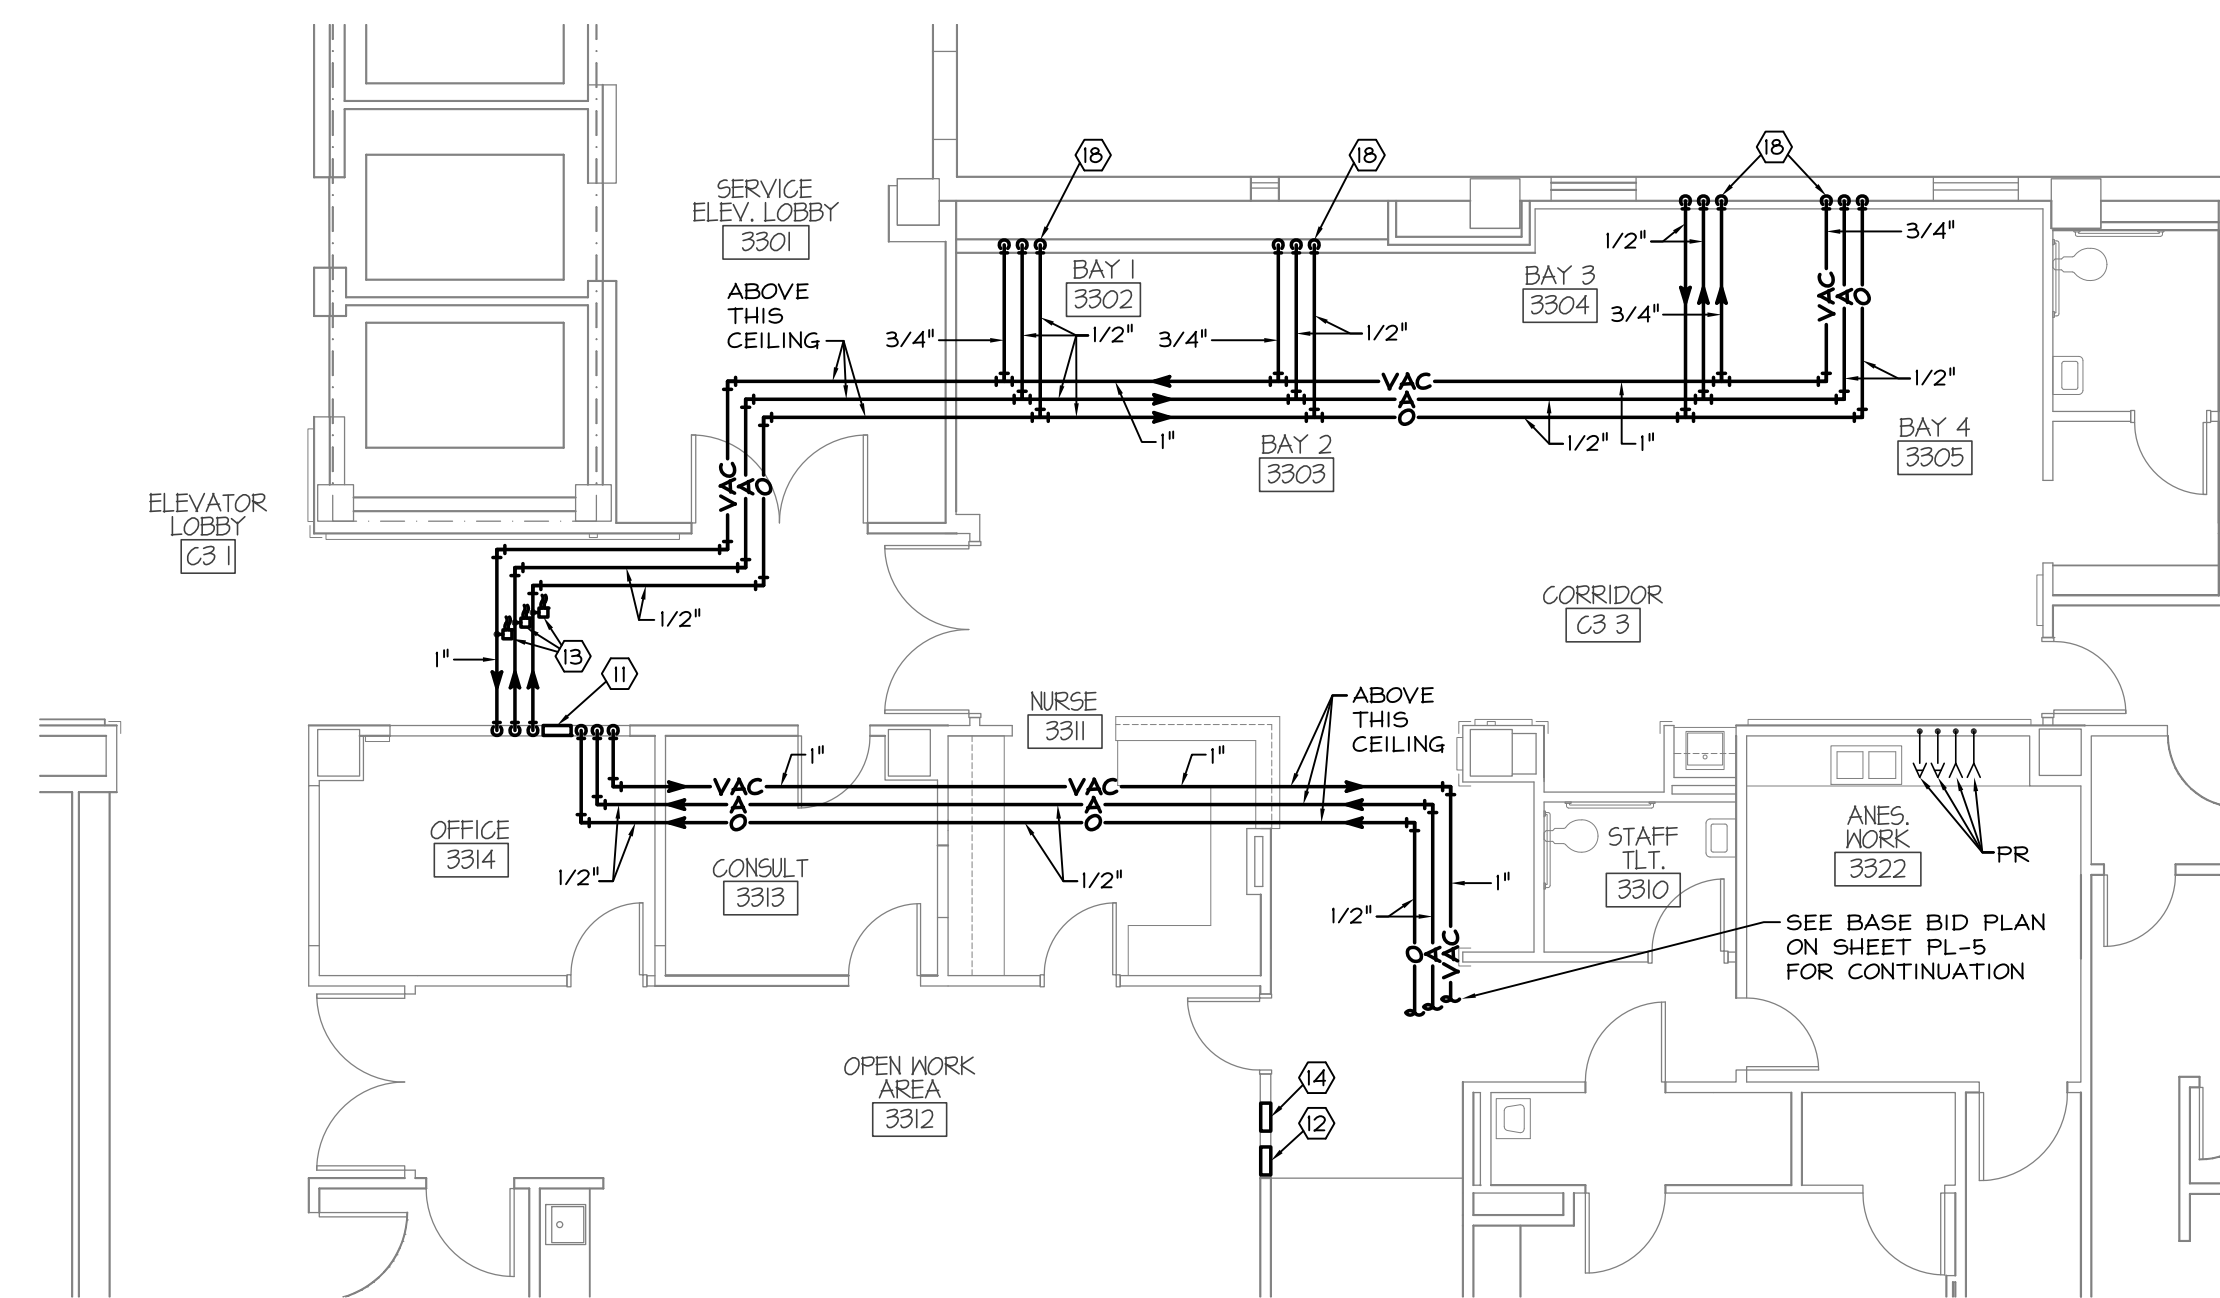


5 ALTERNATE #1 - PARTIAL THIRD FLOOR - MEDICAL GAS NEW WORK
PL-1 1/4" = 1'-0"

KEYED NOTES - PLUMBING
(THIS SHEET)

- 1 CONNECT TO EXISTING COLD WATER LINE ABOVE CEILING.
- 2 CONNECT TO EXISTING HOT WATER LINE ABOVE CEILING.
- 3 CONNECT TO EXISTING VENT STACK ABOVE CEILING.
- 4 CONNECT TO EXISTING SOIL STACK BELOW FLOOR.
- 5 NOT USED.
- 6 NOT USED.
- 7 NOT USED.
- 8 2 1/2" VENT STACK DOWN TO BELOW FLOOR, OFFSET ABOVE 2ND FLOOR CEILING AND RECONNECT IN ORIGINAL LOCATION.
- 9 CONNECT TO EXISTING 5" STORM LINE ABOVE THIS CEILING.
- 10 5" RAIN LEADER DOWN TO BELOW FLOOR, OFFSET ABOVE 2ND FLOOR CEILING AND RECONNECT IN ORIGINAL LOCATION.


KEYED NOTES - MEDICAL GAS
(THIS SHEET)

- 1 NOT USED.
- 2 PRIVATE ROOMS 1 THRU 4 MEDICAL GAS ZONE VALVES - 1" VACUUM, 1/2" MEDICAL AIR AND 1/2" OXYGEN.
- 3 PRIVATE ROOMS 1 THRU 4 MEDICAL GAS AREA ALARM PANEL.
- 4 VACUUM AND PRESSURE TRANSDUCERS FOR PRIVATE ROOMS 1 THRU 4 MEDICAL GAS AREA ALARM PANEL. PROVIDE ALL REQUIRED WIRING BETWEEN TRANSDUCERS AND ALARM PANEL.
- 5 G.I. #1 MEDICAL GAS ZONE VALVES - 1" VACUUM, 1/2" MEDICAL AIR AND 1/2" OXYGEN.
- 6 G.I. #2 MEDICAL GAS ZONE VALVES - 1" VACUUM, 1/2" MEDICAL AIR AND 1/2" OXYGEN.
- 7 G.I. #1 AND #2 MEDICAL GAS AREA ALARM PANEL.
- 8 VACUUM AND PRESSURE TRANSDUCERS FOR G.I. #1 MEDICAL GAS AREA ALARM PANEL. PROVIDE ALL REQUIRED WIRING BETWEEN TRANSDUCERS AND ALARM PANEL.
- 9 VACUUM AND PRESSURE TRANSDUCERS FOR G.I. #2 MEDICAL GAS AREA ALARM PANEL. PROVIDE ALL REQUIRED WIRING BETWEEN TRANSDUCERS AND ALARM PANEL.
- 10 ANESTHESIA WORK MEDICAL GAS ZONE VALVES - 1/2" MEDICAL AIR AND 1/2" OXYGEN.
- 11 PRIVATE ROOMS 1 THRU 4 (OUTPATIENT) MEDICAL GAS ZONE VALVES - 1" VACUUM, 1/2" MEDICAL AIR AND 1/2" OXYGEN.
- 12 BAYS 1 THRU 4 (OUTPATIENT) MEDICAL GAS AREA ALARM PANEL.
- 13 VACUUM AND PRESSURE TRANSDUCERS FOR BAYS 1 THRU 4 (OUTPATIENT) MEDICAL GAS AREA ALARM PANEL. PROVIDE ALL REQUIRED WIRING BETWEEN TRANSDUCERS AND ALARM PANEL.
- 14 RELOCATED MEDICAL GAS AREA ALARM PANEL FOR NITROUS OXIDE, NITROGEN, OXYGEN, MEDICAL AIR AND VACUUM SERVING EXISTING OPERATING ROOM SUITE. PROVIDE NEW PANEL TO REPLACE EXISTING PANEL.
- 15 NOT USED.
- 16 NOT USED.
- 17 NOT USED.
- 18 CONNECT 1/2" OXYGEN, 1/2" MEDICAL AIR AND 3/4" VACUUM TO HEADWALL UNIT. COORDINATE EXACT LOCATION FOR ROUGH-INS IN FIELD WITH SELECTED EQUIPMENT PRIOR TO INSTALLING ANY PIPING.
- 19 NOT USED.
- 20 NOT USED.
- 21 NOT USED.
- 22 COORDINATE EXACT LOCATION OF OXYGEN, MEDICAL AIR AND VACUUM OUTLETS WITH ARCHITECTURAL DRAWINGS. PROVIDE A VACUUM BOTTLE SLIDE BRACKET ADJACENT TO EACH VACUUM OUTLET.
- 23 CONNECT TO EXISTING 1" MEDICAL AIR AND 1" OXYGEN LINES ABOVE CEILING THIS AREA.
- 24 REMOVE CAP AND CONNECT TO EXISTING 3" VALVED VACUUM OUTLET ABOVE CEILING THIS AREA.
- 25 COORDINATE EXACT LOCATION OF OXYGEN AND MEDICAL AIR OUTLETS IN FIELD WITH COTE.
- 26 NOT USED.
- 27 CONNECT TO EXISTING 1" OXYGEN LINE ABOVE CEILING THAT SERVES EXISTING 1" OXYGEN RISER IN SHAFT.
- 28 AIR COMPRESSOR BELOW COUNTER FOR BLOWING OUT SCOPES. SEE SCHEMATIC ON DWG. PL-0.
- 29 COORDINATE EXACT LOCATION OF OXYGEN, MEDICAL AIR AND VACUUM CEILING OUTLETS WITH ARCHITECTURAL DRAWINGS.

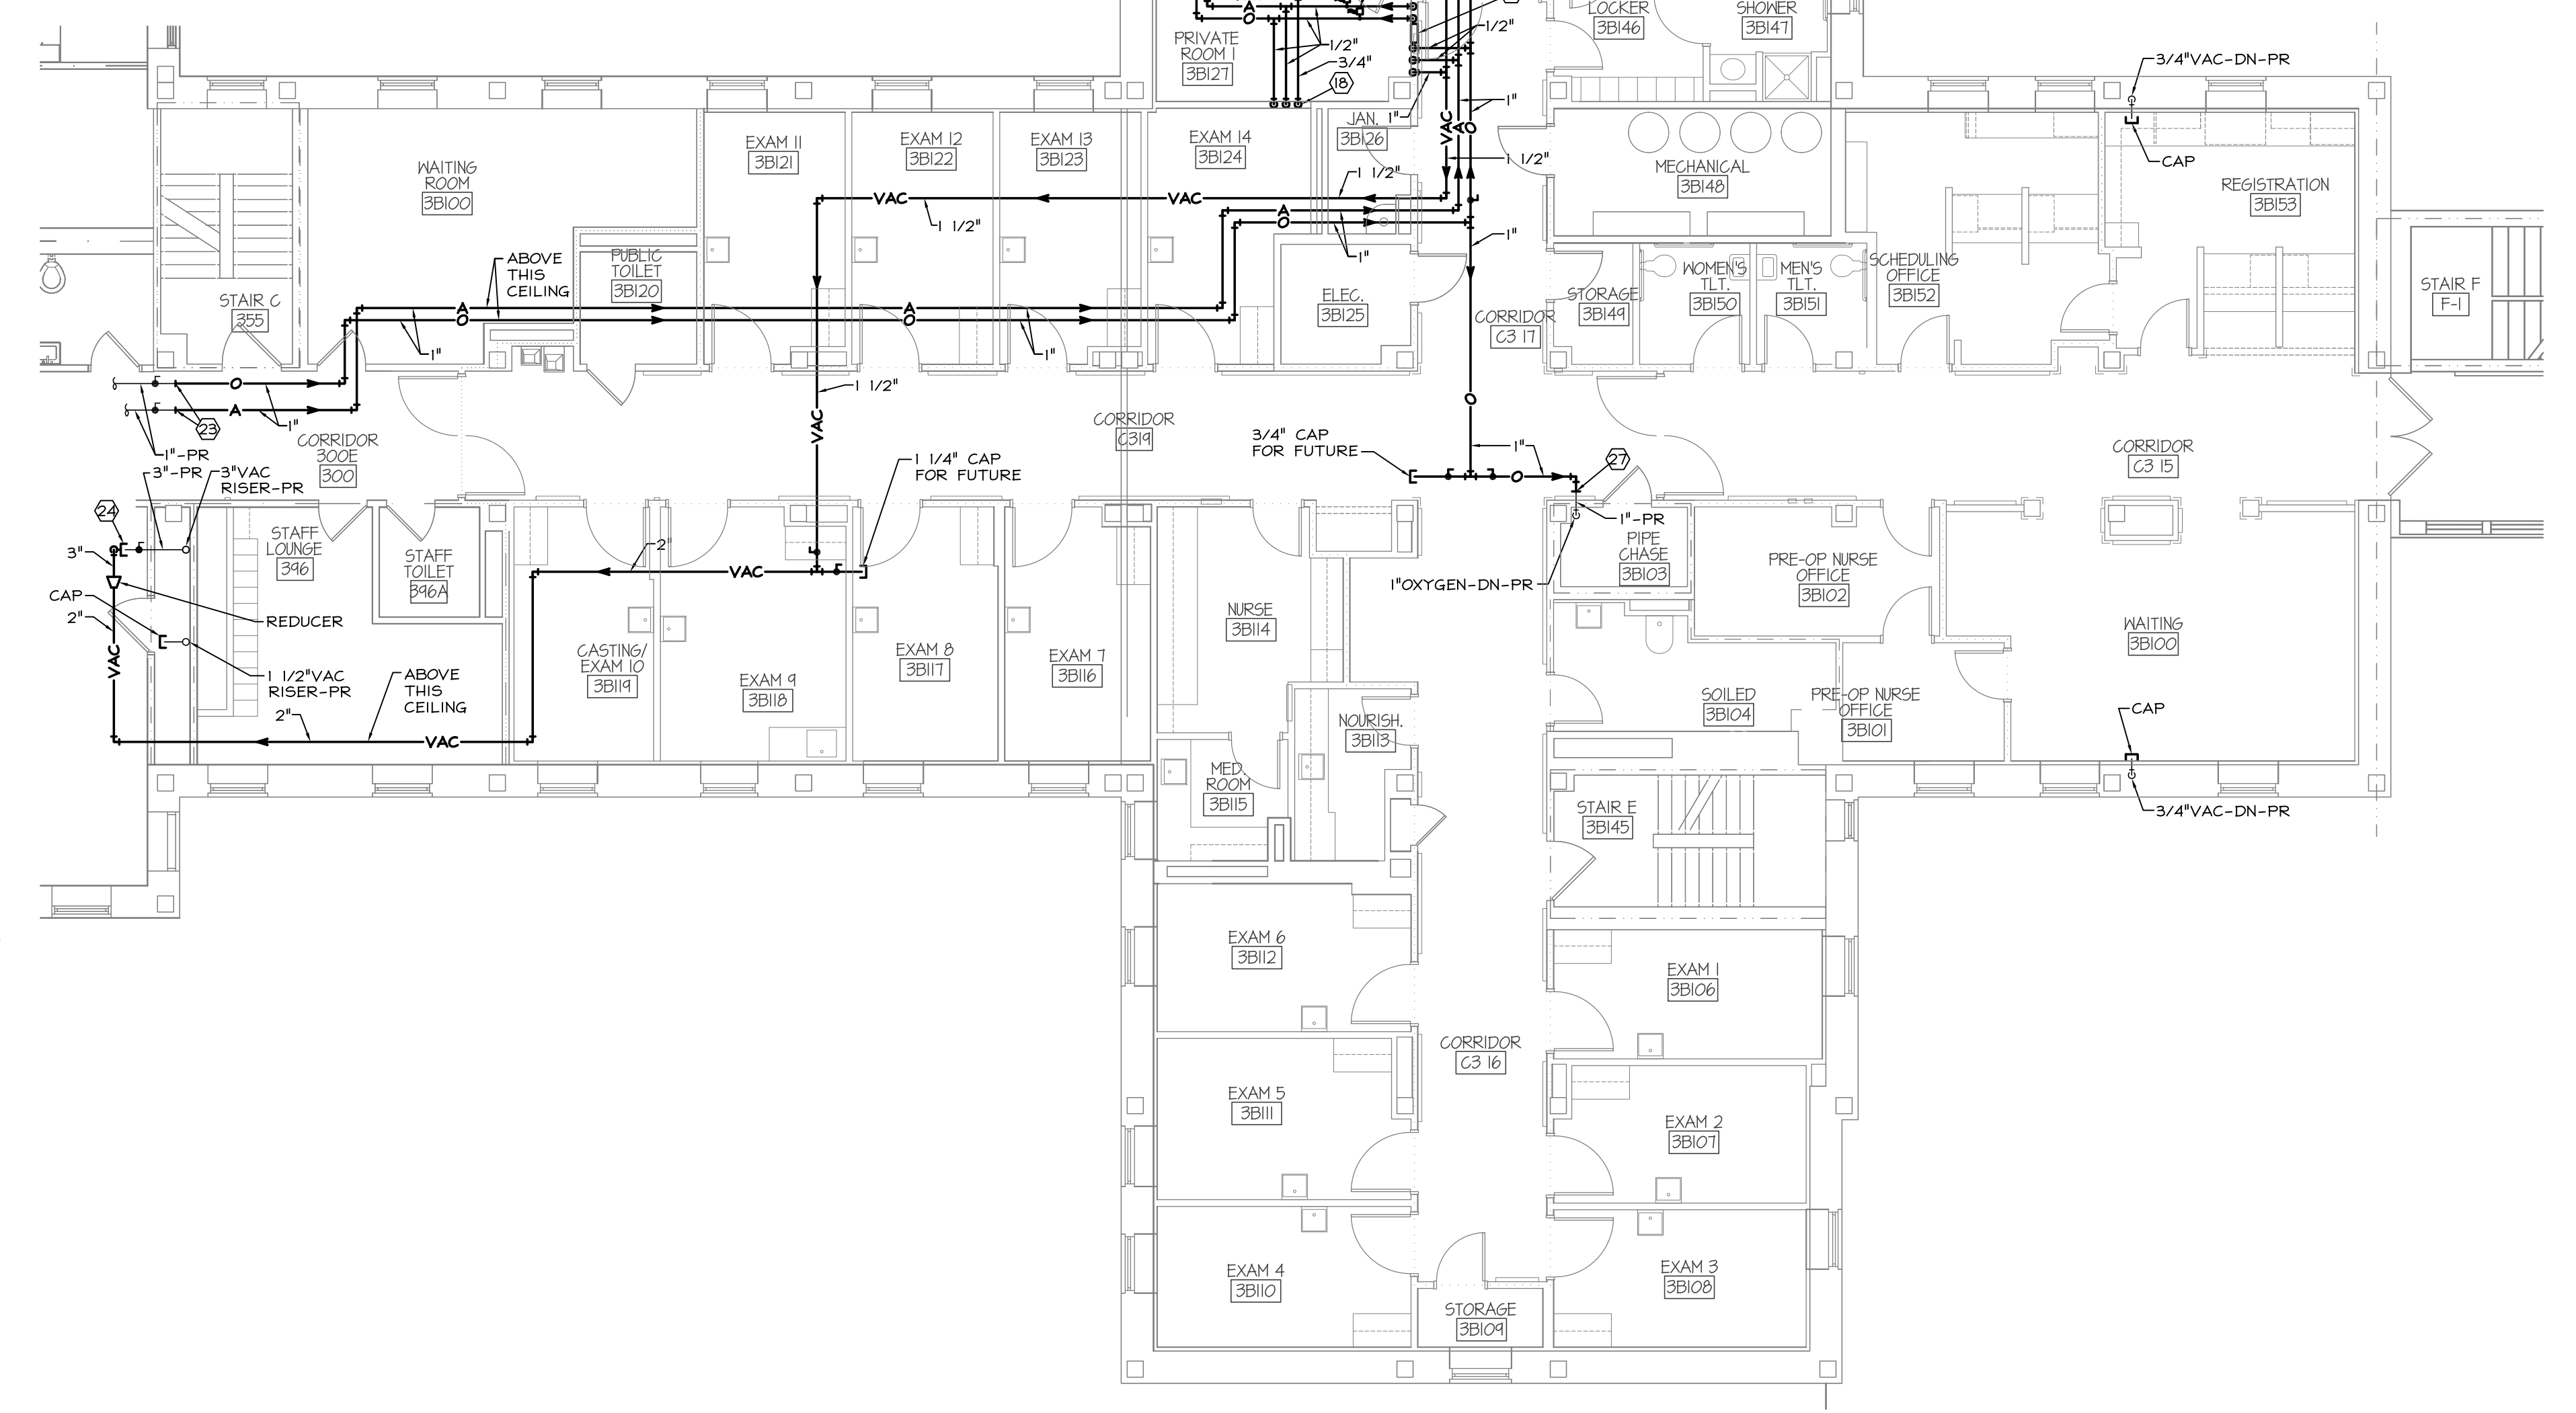


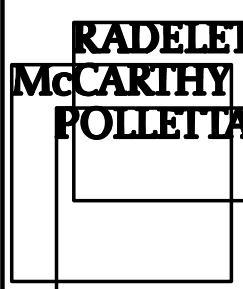
4 ALTERNATE #6 - PARTIAL THIRD FLOOR - MEDICAL GAS NEW WORK
PL-1 1/4" = 1'-0"

REVISIONS	DATE



DEPT. OF VETERANS AFFAIRS
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APPROVED: DIRECTOR	APPROVED: CHIEF FMS
APPROVED: ASSOCIATE DIRECTOR	APPROVED: ASSISTANT CHIEF FMS
APPROVED: CHIEF OF STAFF	
APPROVED: VP SURGICAL SPECIALTIES	

DRAWING TITLE THIRD FLOOR ALTERNATES - PLUMBING	
PROJECT NO. 540-310	ARCH. PROJECT NO. 09050
BUILDING NO.	AUTOCAD FILE NAME: 3-VA-Clarksbu09050 - Modernize Ambulatory Surgery Drawings 010428 - Plumbing 10428 - PL-1

PROJECT TITLE MODERNIZE AMBULATORY SURGERY	
DESIGNED BY: DEE	DRAWN BY: JE
CHECKED BY: CEM	
LOCATION VAMC CLARKSBURG, WV	



ENGINEERING, INC.
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(412) 271-5040 PHONE (412) 271-5145 FAX
FILE NO. 110428

DATE
4/22/2010



SCALE
AS NOTED

DRAWING NO.
PL-7



SHEET 51 OF 65


DEPARTMENT OF
VETERANS AFFAIRS

ISSUED FOR:
RECORD
05.10.13

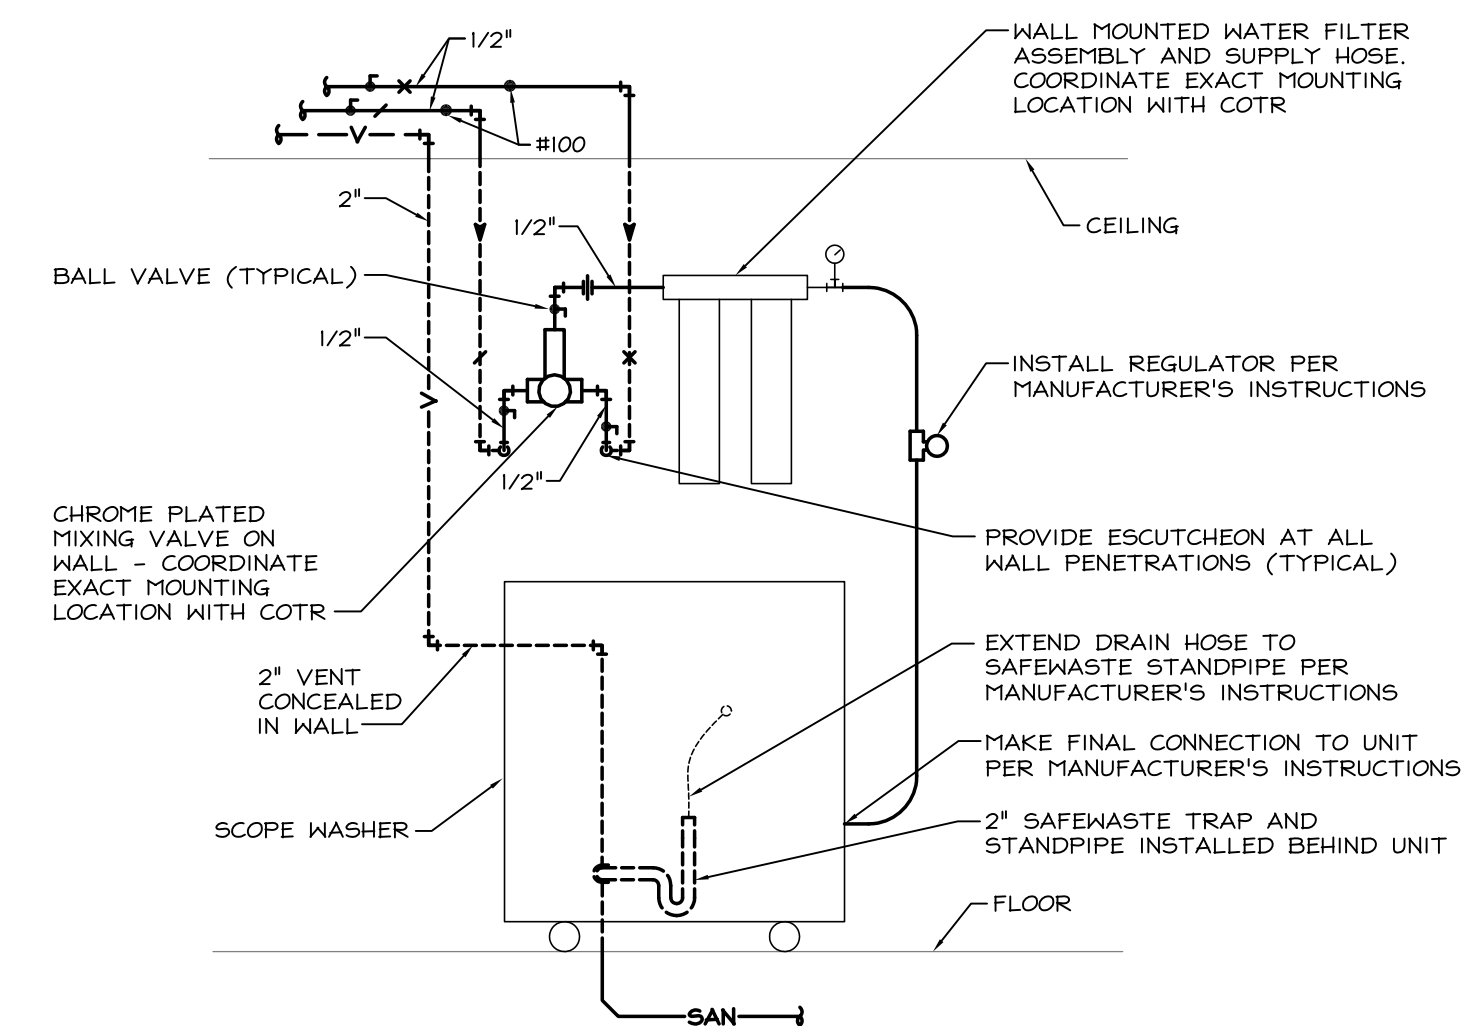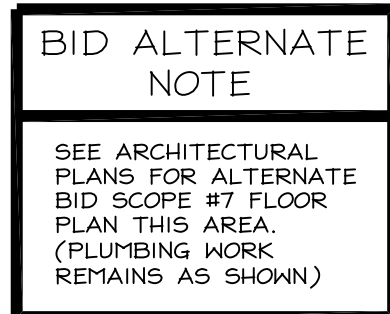


1 ENLARGED PARTIAL THIRD FLOOR - PLUMBING NEW WORK
PL-3 1/4" = 1'-0"

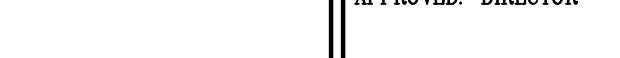REVISIONS		DATE		<div></div> <div>DEPT. OF VETERANS AFFAIRS LOUIS A. JOHNSON VAMC CLARKSBURG, WV 26301</div> <div></div> <div><div><div>RADELETT MCCARTHY POLLETTA</div><div><div>300 First & Market Building 100 First Avenue Pittsburgh, PA 15222 T. 412.471.4445 F. 412.471.2881 www.radeletmccarthy.com</div></div></div><div>Architects and Interior Designers</div></div>		APPROVED: DIRECTOR		APPROVED: CHIEF FMS		DRAWING TITLE THIRD FLOOR – PLUMBING NEW WORK		PROJECT TITLE MODERNIZE AMBULATORY SURGERY		DATE 4/22/2010		DEPARTMENT OF VETERANS AFFAIRS		
						APPROVED: ASSOCIATE DIRECTOR		APPROVED: ASSISTANT CHIEF FMS				SCALE AS NOTED						
						APPROVED: CHIEF OF STAFF				PROJECT NO. 540–310		ARCH. PROJECT NO. 09050		DESIGNED BY: DEE	DRAWN BY: JE		CHECKED BY: CEM	PL-3 SHEET 47 OF 65
						APPROVED: VP SURGICAL SPECIALTIES				BUILDING NO.		AUTOCAD FILE NAME: 3 VA Clarksburg J0905 - Modernize Ambulatory Surgery Overlays.dwg 040428 Pittsburgh J0905 - 16-3		LOCATION VAMC CLARKSBURG, WV				

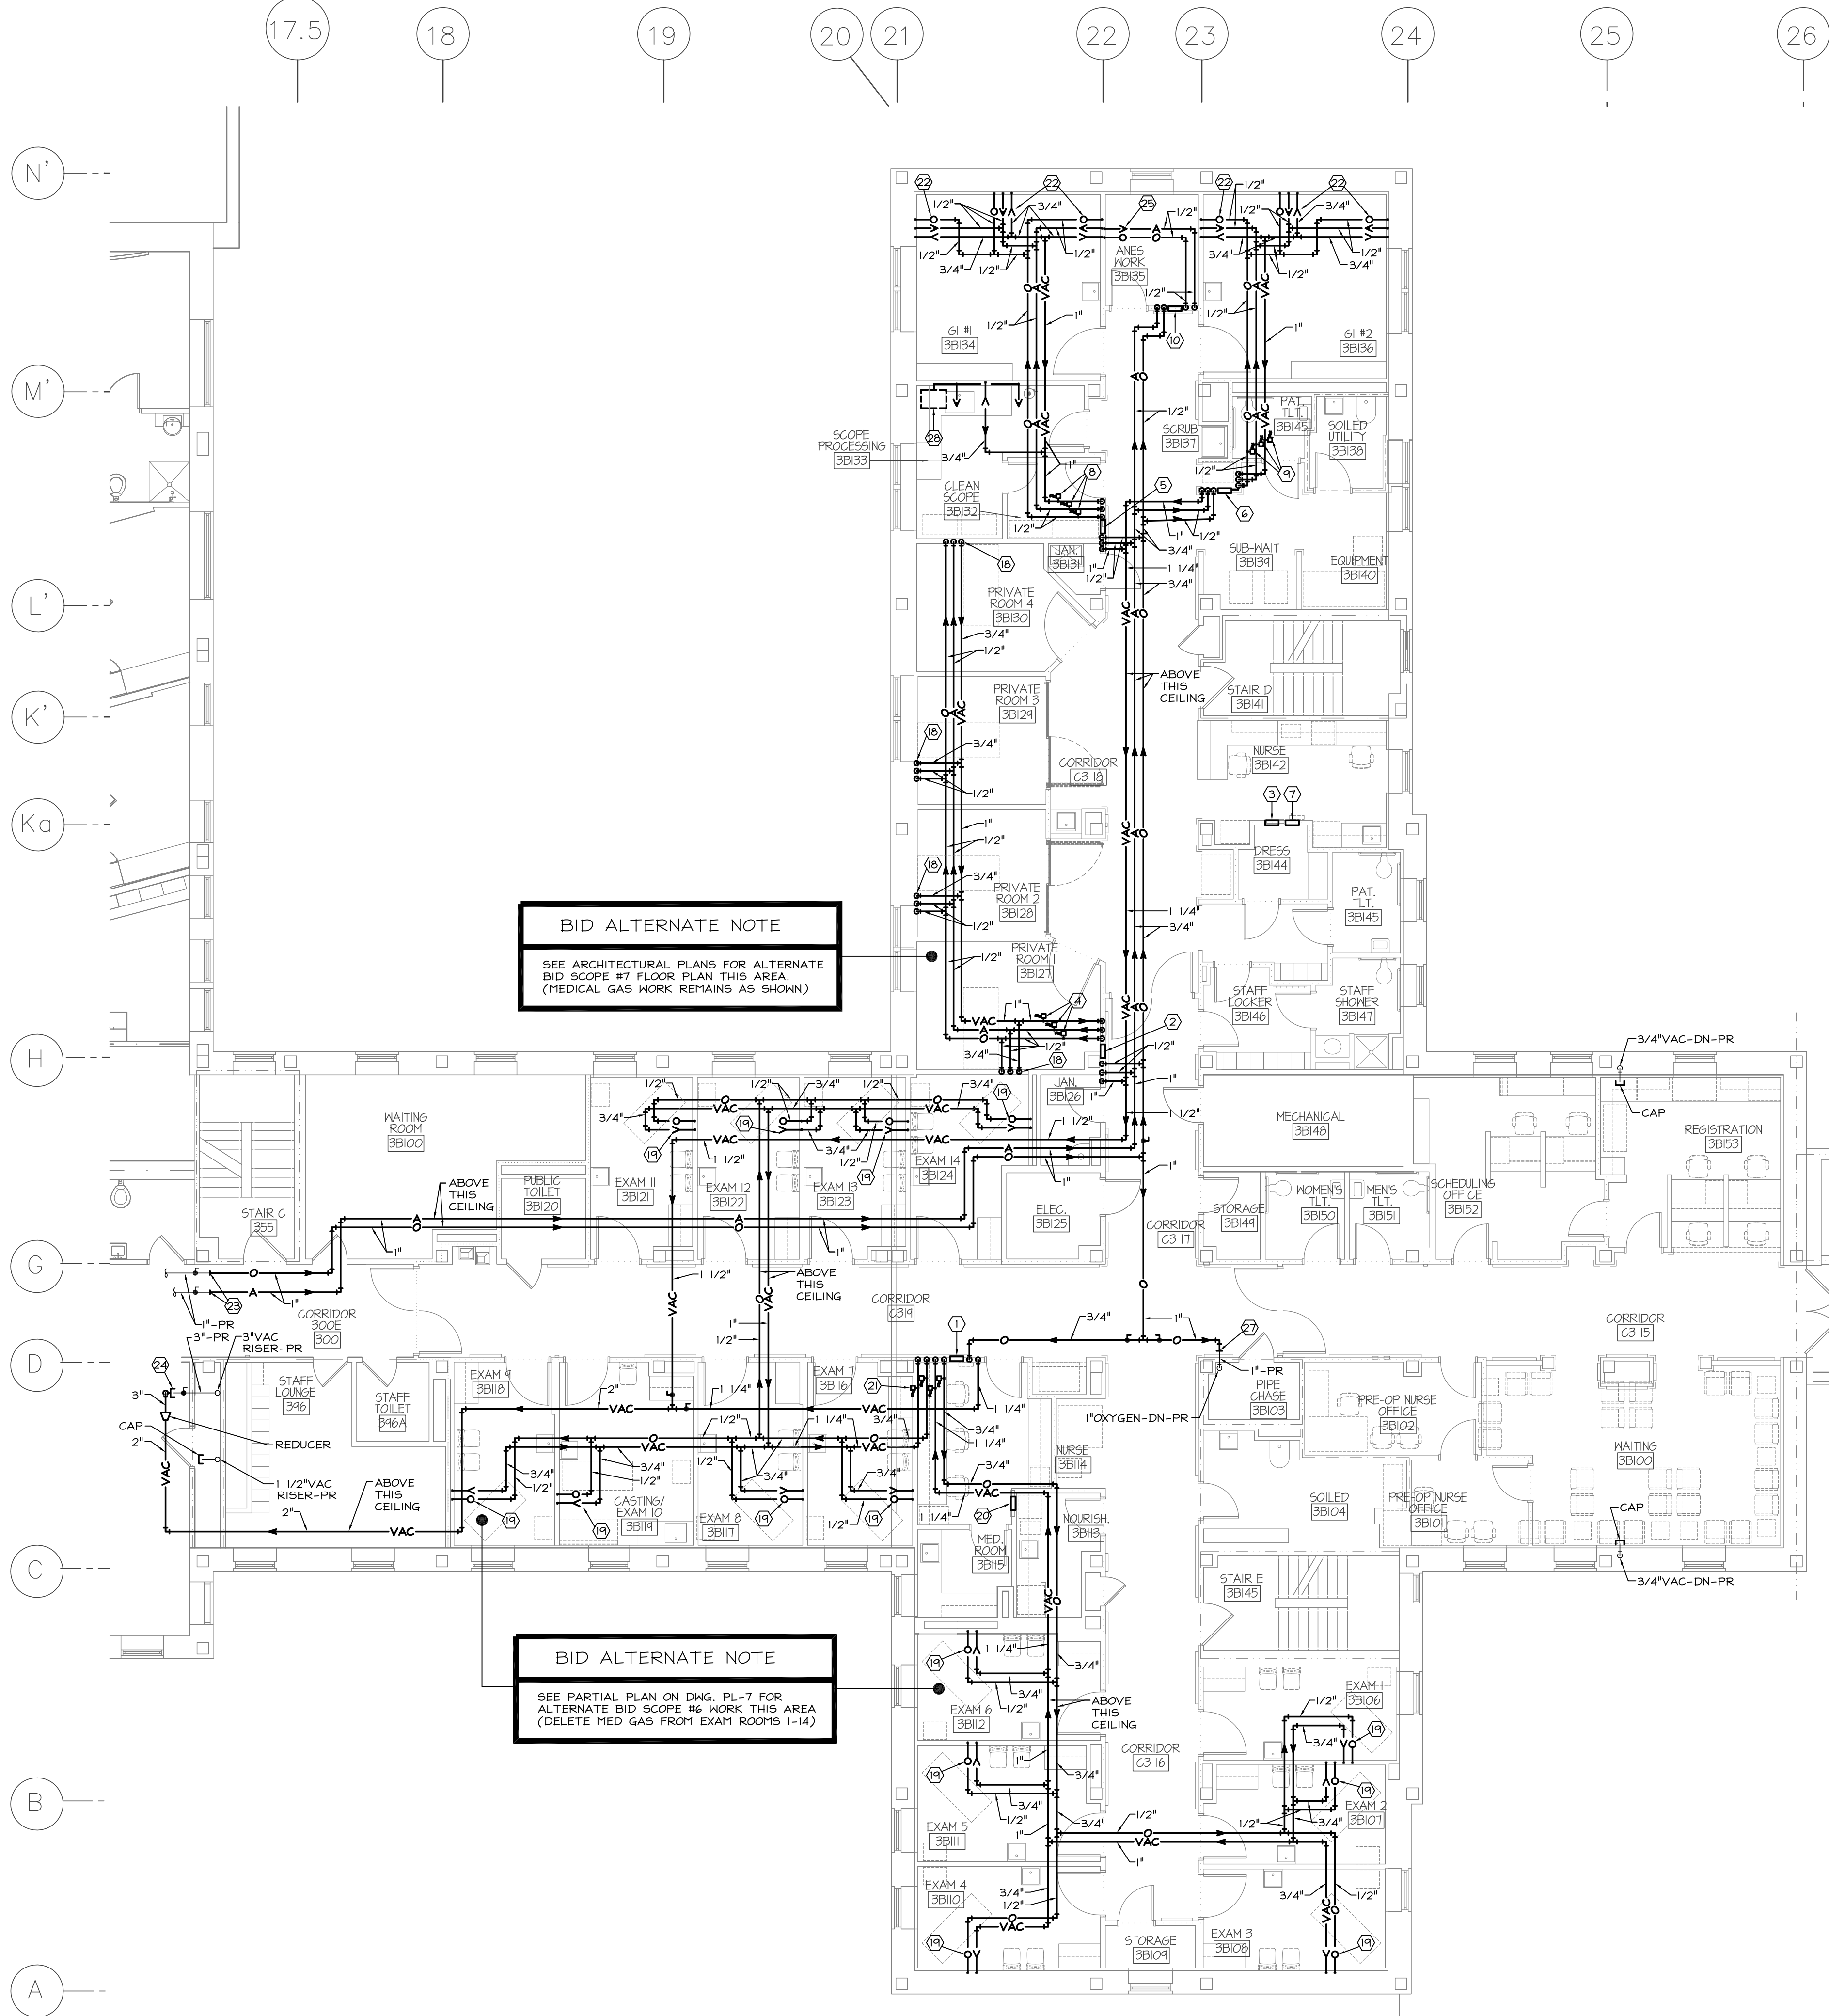

KEYED PLUMBING NOTES (THIS SHEET)

- (2) SETS OF STACKED MEDICAL GAS ZONE VALVES. TOP SET SHALL BE 1 1/4" VACUUM AND 3/4" OXYGEN TO SERVE EXAM ROOMS 1 THRU 6. THE BOTTOM SET SHALL BE 1 1/4" VACUUM AND 3/4" OXYGEN TO SERVE EXAM ROOMS 7 THRU 14. SEE SCHEMATIC THIS SHEET.
- PRIVATE ROOMS 1 THRU 4 MEDICAL GAS ZONE VALVES - 1" VACUUM, 1/2" MEDICAL AIR AND 1/2" OXYGEN.
- PRIVATE ROOMS 1 THRU 4 MEDICAL GAS AREA ALARM PANEL.
- VACUUM AND PRESSURE TRANSDUCERS FOR PRIVATE ROOMS 1 THRU 4 MEDICAL GAS AREA ALARM PANEL. PROVIDE ALL REQUIRED WIRING BETWEEN TRANSDUCERS AND ALARM PANEL.
- G.I. #1 MEDICAL GAS ZONE VALVES - 1" VACUUM, 1/2" MEDICAL AIR AND 1/2" OXYGEN.
- G.I. #2 MEDICAL GAS ZONE VALVES - 1" VACUUM, 1/2" MEDICAL AIR AND 1/2" OXYGEN.
- G.I. #1 AND #2 MEDICAL GAS AREA ALARM PANEL.
- VACUUM AND PRESSURE TRANSDUCERS FOR G.I. #1 MEDICAL GAS AREA ALARM PANEL. PROVIDE ALL REQUIRED WIRING BETWEEN TRANSDUCERS AND ALARM PANEL.
- VACUUM AND PRESSURE TRANSDUCERS FOR G.I. #2 MEDICAL GAS AREA ALARM PANEL. PROVIDE ALL REQUIRED WIRING BETWEEN TRANSDUCERS AND ALARM PANEL.
- ANESTHESIA WORK MEDICAL GAS ZONE VALVES - 1/2" MEDICAL AIR AND 1/2" OXYGEN.
- PRIVATE ROOMS 1 THRU 4 (OUTPATIENT) MEDICAL GAS ZONE VALVES - 1" VACUUM, 1/2" MEDICAL AIR AND 1/2" OXYGEN.
- PRIVATE ROOMS 1 THRU 4 (OUTPATIENT) MEDICAL GAS AREA ALARM PANEL.
- VACUUM AND PRESSURE TRANSDUCERS FOR PRIVATE ROOMS 1 THRU 4 (OUTPATIENT) MEDICAL GAS AREA ALARM PANEL. PROVIDE ALL REQUIRED WIRING BETWEEN TRANSDUCERS AND ALARM PANEL.
- RELOCATED MEDICAL GAS AREA ALARM PANEL FOR NITROUS OXIDE, NITROGEN, OXYGEN, MEDICAL AIR AND VACUUM SERVING EXISTING OPERATING ROOM SUITE. PROVIDE NEW PANEL TO REPLACE EXISTING PANEL.
- CONNECT TO EXISTING VACUUM, MEDICAL AIR AND OXYGEN LINES ABOVE CEILING.
- VACUUM, MEDICAL AIR, NITROUS OXIDE, NITROGEN AND OXYGEN ZONE VALVES - PR.
- VACUUM AND MEDICAL AIR ZONE VALVES - PR.
- CONNECT 1/2" OXYGEN, 1/2" MEDICAL AIR AND 3/4" VACUUM TO HEADWALL UNIT. COORDINATE EXACT LOCATION FOR ROUGH-INS IN FIELD WITH SELECTED EQUIPMENT PRIOR TO INSTALLING ANY PIPING.
- COORDINATE EXACT LOCATION OF OXYGEN AND VACUUM OUTLETS WITH ARCHITECTURAL DRAWINGS. PROVIDE A VACUUM BOTTLE SLIDE BRACKET ADJACENT TO EACH VACUUM OUTLET.
- EXAM ROOMS 1 THRU 6 AND 7 THRU 14 MEDICAL GAS AREA ALARM PANELS.
- VACUUM AND PRESSURE TRANSDUCERS FOR EXAM ROOMS 1 THRU 6 AND 7 THRU 14 MEDICAL GAS AREA ALARM PANELS. PROVIDE ALL REQUIRED WIRING BETWEEN TRANSDUCERS AND ALARM PANELS.
- COORDINATE EXACT LOCATION OF OXYGEN, MEDICAL AIR AND VACUUM OUTLETS WITH ARCHITECTURAL DRAWINGS. PROVIDE A VACUUM BOTTLE SLIDE BRACKET ADJACENT TO EACH VACUUM OUTLET.
- CONNECT TO EXISTING 1" MEDICAL AIR AND 1" OXYGEN LINES ABOVE CEILING THIS AREA.
- REMOVE CAP AND CONNECT TO EXISTING 3" VALVED VACUUM OUTLET ABOVE CEILING THIS AREA.
- COORDINATE EXACT LOCATION OF OXYGEN AND MEDICAL AIR OUTLETS IN FIELD WITH CONTR.
- CONNECT TO EXISTING NITROUS OXIDE, NITROGEN, OXYGEN, MEDICAL AIR AND VACUUM LINES ABOVE CEILING AND INSTALL NEW PRESSURE AND VACUUM TRANSDUCERS FOR EXISTING OPERATING ROOM SUITE. PROVIDE ALL REQUIRED WIRING BETWEEN TRANSDUCERS AND ALARM PANEL. REMOVE AND CAP ALL PIPING THAT SERVED PANEL IN ORIGINAL LOCATION.
- CONNECT TO EXISTING 1" OXYGEN LINE ABOVE CEILING THAT SERVES EXISTING 1" OXYGEN RISER IN SHAF.
- AIR COMPRESSOR BELOW COUNTER FOR BLOWING OUT SCOPES. SEE SCHEMATIC ON DWG. PL-5.
- OMITTED.

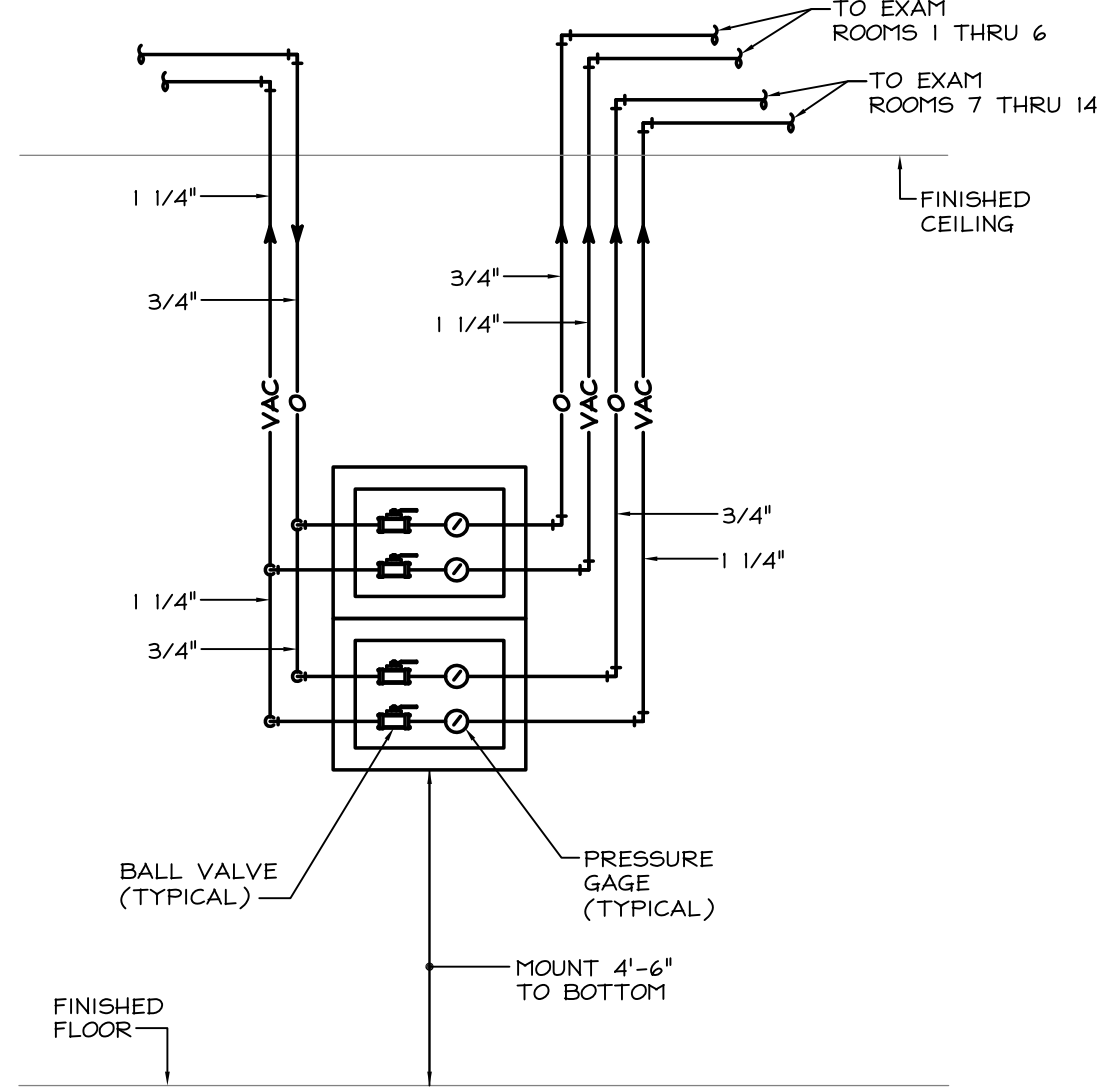

STACKED MEDICAL GAS ZONE VALVES

NOT TO SCALE

NOTE: INSTALLATION IS SIMILAR FOR SINGLE BOXES WITH MULTIPLE VALVES. ALL ASSEMBLIES SHALL BE MOUNTED 4'-6" ABOVE FINISHED FLOOR TO BOTTOM OF ASSEMBLY.

BID ALTERNATE NOTE

SEE ARCHITECTURAL PLANS FOR ALTERNATE BID SCOPE #7 FLOOR PLAN THIS AREA (MEDICAL GAS WORK REMAINS AS SHOWN)

BID ALTERNATE NOTE


SEE PARTIAL PLAN ON DWG. PL-7 FOR ALTERNATE BID SCOPE #6 WORK THIS AREA (DELETE MED GAS FROM EXAM ROOMS 1-14)

BID ALTERNATE NOTE


SEE PARTIAL PLAN ON DWG. PL-7 FOR ALTERNATE BID SCOPE #7 THIS AREA


1 THIRD FLOOR - MEDICAL GAS NEW WORK
PL-5 1/8" = 1'-0"

REVISIONS	DATE



DEPT. OF VETERANS AFFAIRS
LOUIS A. JOHNSON VAMC
CLARKSBURG, WV 26301



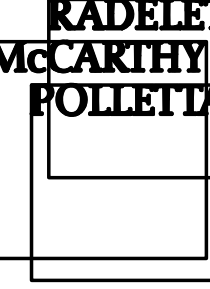

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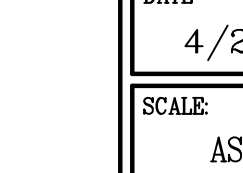
Architects and Interior Designers

APPROVED: DIRECTOR	APPROVED: CHIEF FMS
APPROVED: ASSOCIATE DIRECTOR	APPROVED: ASSISTANT CHIEF FMS
APPROVED: CHIEF OF STAFF	
APPROVED: VP SURGICAL SPECIALTIES	

DRAWING TITLE THIRD FLOOR - MEDICAL GAS NEW WORK	
PROJECT NO. 540-310	ARCH. PROJECT NO. 09050
BUILDING NO.	AUTOCAD FILE NAME: 3-14-Clarksbu09050 - Modernize Ambulatory Surgery Drawing.dwg 11/04/20 - Plumbing 11/04/20 - PL-5

PROJECT TITLE MODERNIZE AMBULATORY SURGERY		
DESIGNED BY: DEE	DRAWN BY: JE	CHECKED BY: CEM
LOCATION VAMC CLARKSBURG, WV		

ISSUED FOR: RECORD 05.10.13	
DATE 4/22/2010	SCALE AS NOTED
DRAWING NO. PL-5	SHEET 49 OF 65



FIRSCHING,
MARSTELLER,
RIEBSKY AND
WOLF

ENGINEERING, INC.

1500 ARCHBOLD BOULEVARD, SUITE 200
PITTSBURGH, PA 15221
(412) 271-5040 PHONE (412) 271-5145 FAX
FILE NO. 110428

DEPARTMENT OF
VETERANS AFFAIRS

DRAWING NOTES:

- 6x6"EG, 75 CFM; 8x4"EA BRANCH DUCT.
- 10x10"RG, 440 CFM.
- 8x8"RG, 120 CFM; 10x6"RA BRANCH DUCT.
- RT-6; 75/75.
- 6x6"SD, 3-WAY; 75 CFM; 8x6"SA BRANCH DUCT.
- 8x8"EG, 220 CFM; 10x6"EA BRANCH DUCT.
- 8x8"EG, 235 CFM; 10x6"EA BRANCH DUCT.
- 6x6"RG, 100 CFM; 8x6"EA BRANCH DUCT.
- RELOCATED SUPPLY AIR DIFFUSER.
- RELOCATED 48x24" RETURN AIR REGISTER, TRANSITION AS REQUIRED.
- RELOCATE EXISTING RETURN GRILLE INTO CEILING GRID, BALANCE FOR 155 CFM.
- 6x6"SD, 2-WAY; 50 CFM; 8x4"SA BRANCH DUCT.
- 12x12"SD, 2-WAY; 420 CFM; 14x7"SA BRANCH DUCT.
- RT-6; 200/200.
- 12x12"SD, 340 CFM; 14x6"SA BRANCH DUCT.
- 6x6"SD, 2-WAY; 120 CFM.
- RT-6; 340/170.
- INTERNALLY LINE EXHAUST PLENUM AND EXHAUST AIR DUCTWORK FOR A DISTANCE OF 10'-0" ON EITHER SIDE OF EXHAUST FAN. LINER SHALL BE 3/4" THICK MATTE-FACED FOR NOISE CONTROL.
- FOR VERTICAL FIRE DAMPER INSTALLATION, SEE DETAIL 15.
- FOR INSTALLATION OF REHEAT AIR TERMINAL, SEE DETAIL 2.
- FOR CONTINUATION OF DUCTWORK, SEE PLAN 11.
- FOR INSTALLATION OF EXHAUST FAN, SEE DETAIL 11.
- PROVIDE VIBRATION ISOLATION HANGERS AND ALL MISCELLANEOUS STEEL REQUIRED TO HANG THE NEW EXHAUST FAN.
- FOR HORIZONTAL FIRE DAMPER INSTALLATION, SEE DETAIL 3.
- 8x8"RG, 215 CFM; 10x6"RA BRANCH DUCT.
- 10x10"RG, 280 CFM; 12x7"RA BRANCH DUCT.
- RT-6; 160/80.
- 8x8"RG, 175 CFM; 10x6"RA BRANCH DUCT.
- 20x40"SA UP TO FOURTH FLOOR ABOVE. FOR CONTINUATION, SEE DRAWING MH-7.
- 54x24"RA UP TO FOURTH FLOOR ABOVE. FOR CONTINUATION, SEE DRAWING MH-7.
- CUT WALL OPENING AND PROVIDE MISCELLANEOUS STEEL FOR FRAMING OPENING.
- PROVIDE TRANSITION FROM 12x18"EA TO FAN OPENING SIZE.

THIRD FLOOR - HVAC NEW WORK

1/4" = 1'-0"



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APPROVED: DIRECTOR

APPROVED: ASSOCIATE DIRECTOR

APPROVED: CHIEF OF STAFF

APPROVED: VP SURGICAL SPECIALTIES

APPROVED: CHIEF FMS

APPROVED: ASSISTANT CHIEF FMS

DRAWING TITLE

THIRD FLOOR -
HVAC NEW WORK

PROJECT NO.

540-310

BUILDING NO.

ARCH. PROJECT NO.

09050

AUTOCAD FILE NAME:

11-VA-Campbell-Johnson-Modernize
Ambulatory Surgery/Operating/110428
-HVAC/110428 - MH-4

ISSUED FOR

RECORD
05.10.13

PROJECT TITLE

MODERNIZE
AMBULATORY SURGERY

DESIGNED BY

DRAWN BY

CHECKED BY

LOCATION

VAMC CLARKSBURG, WV

**FIRSCHING,
MARSTILLER,
RUEBARKY AND
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FILE NO. 110428

DATE

4/22/2010

SCALE


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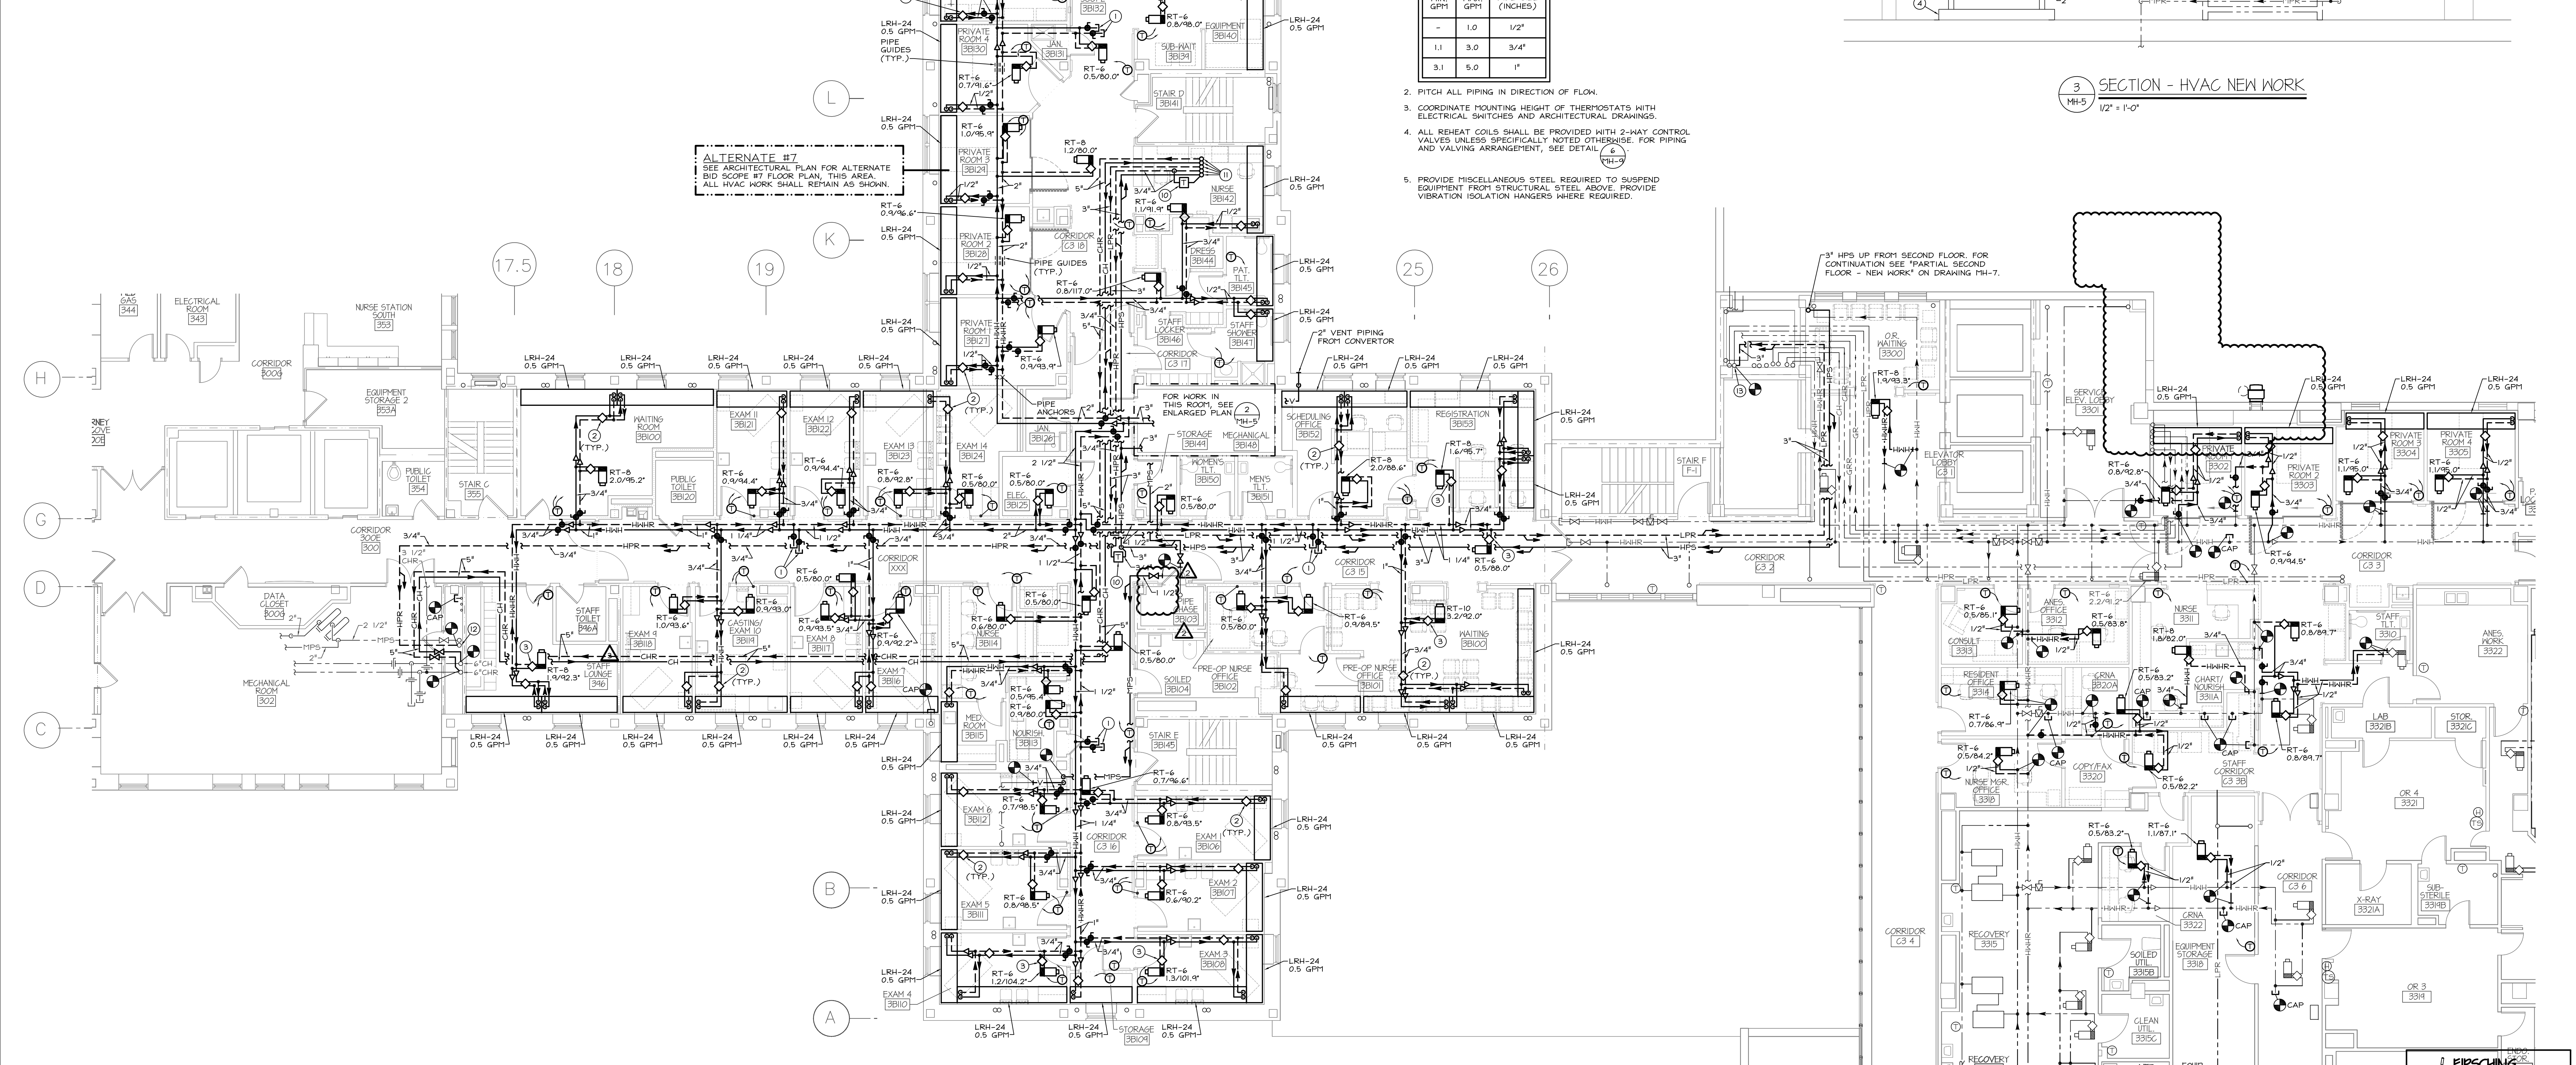
MH-4

SHEET 39 OF 69

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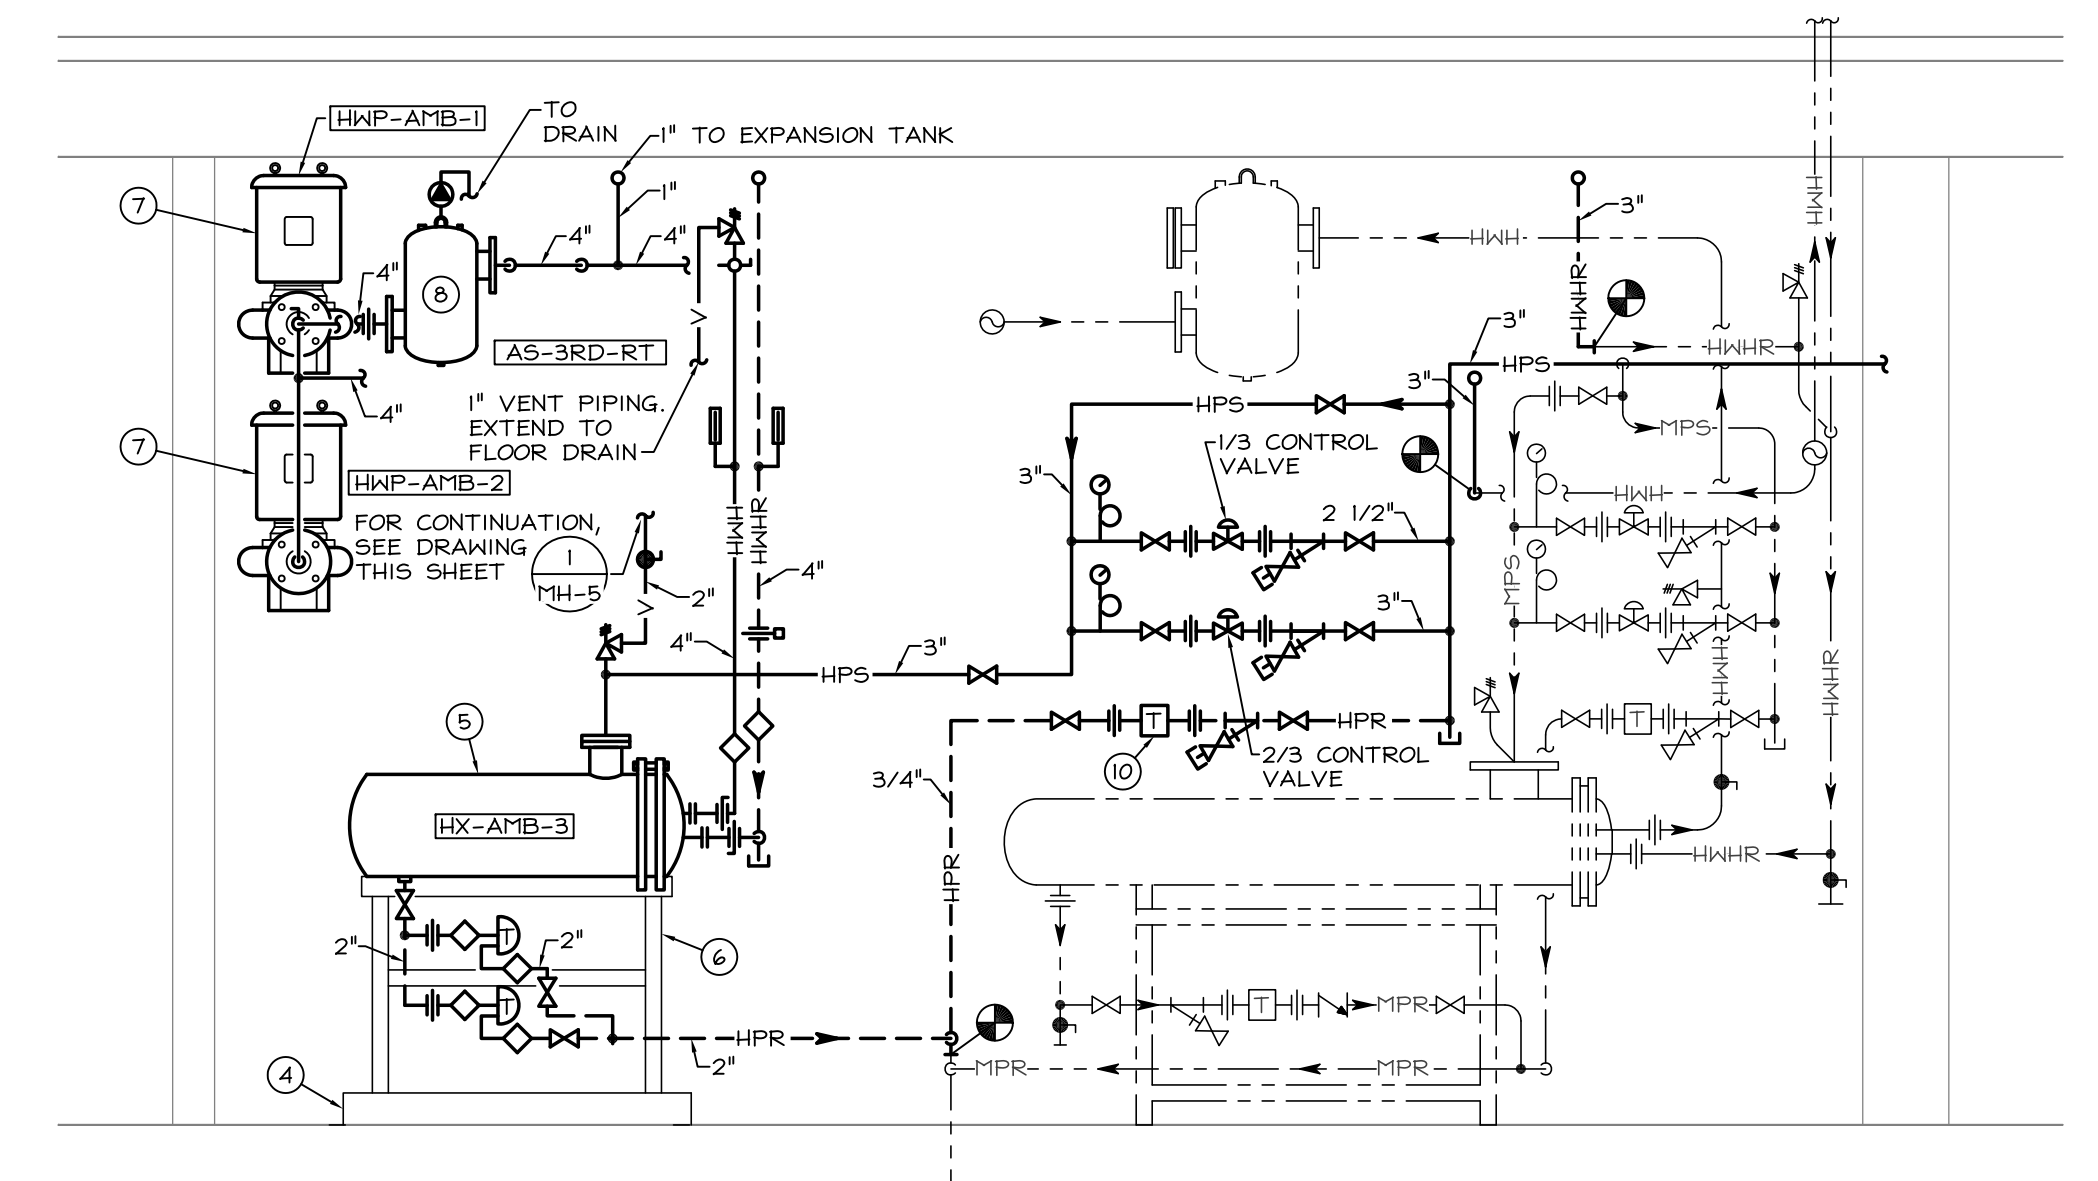
2 ENLARGED MECHANICAL ROOM - HVAC NEW WORK
1/2" = 1'-0"



1 THIRD FLOOR - HVAC NEW WORK
1/8" = 1'-0"

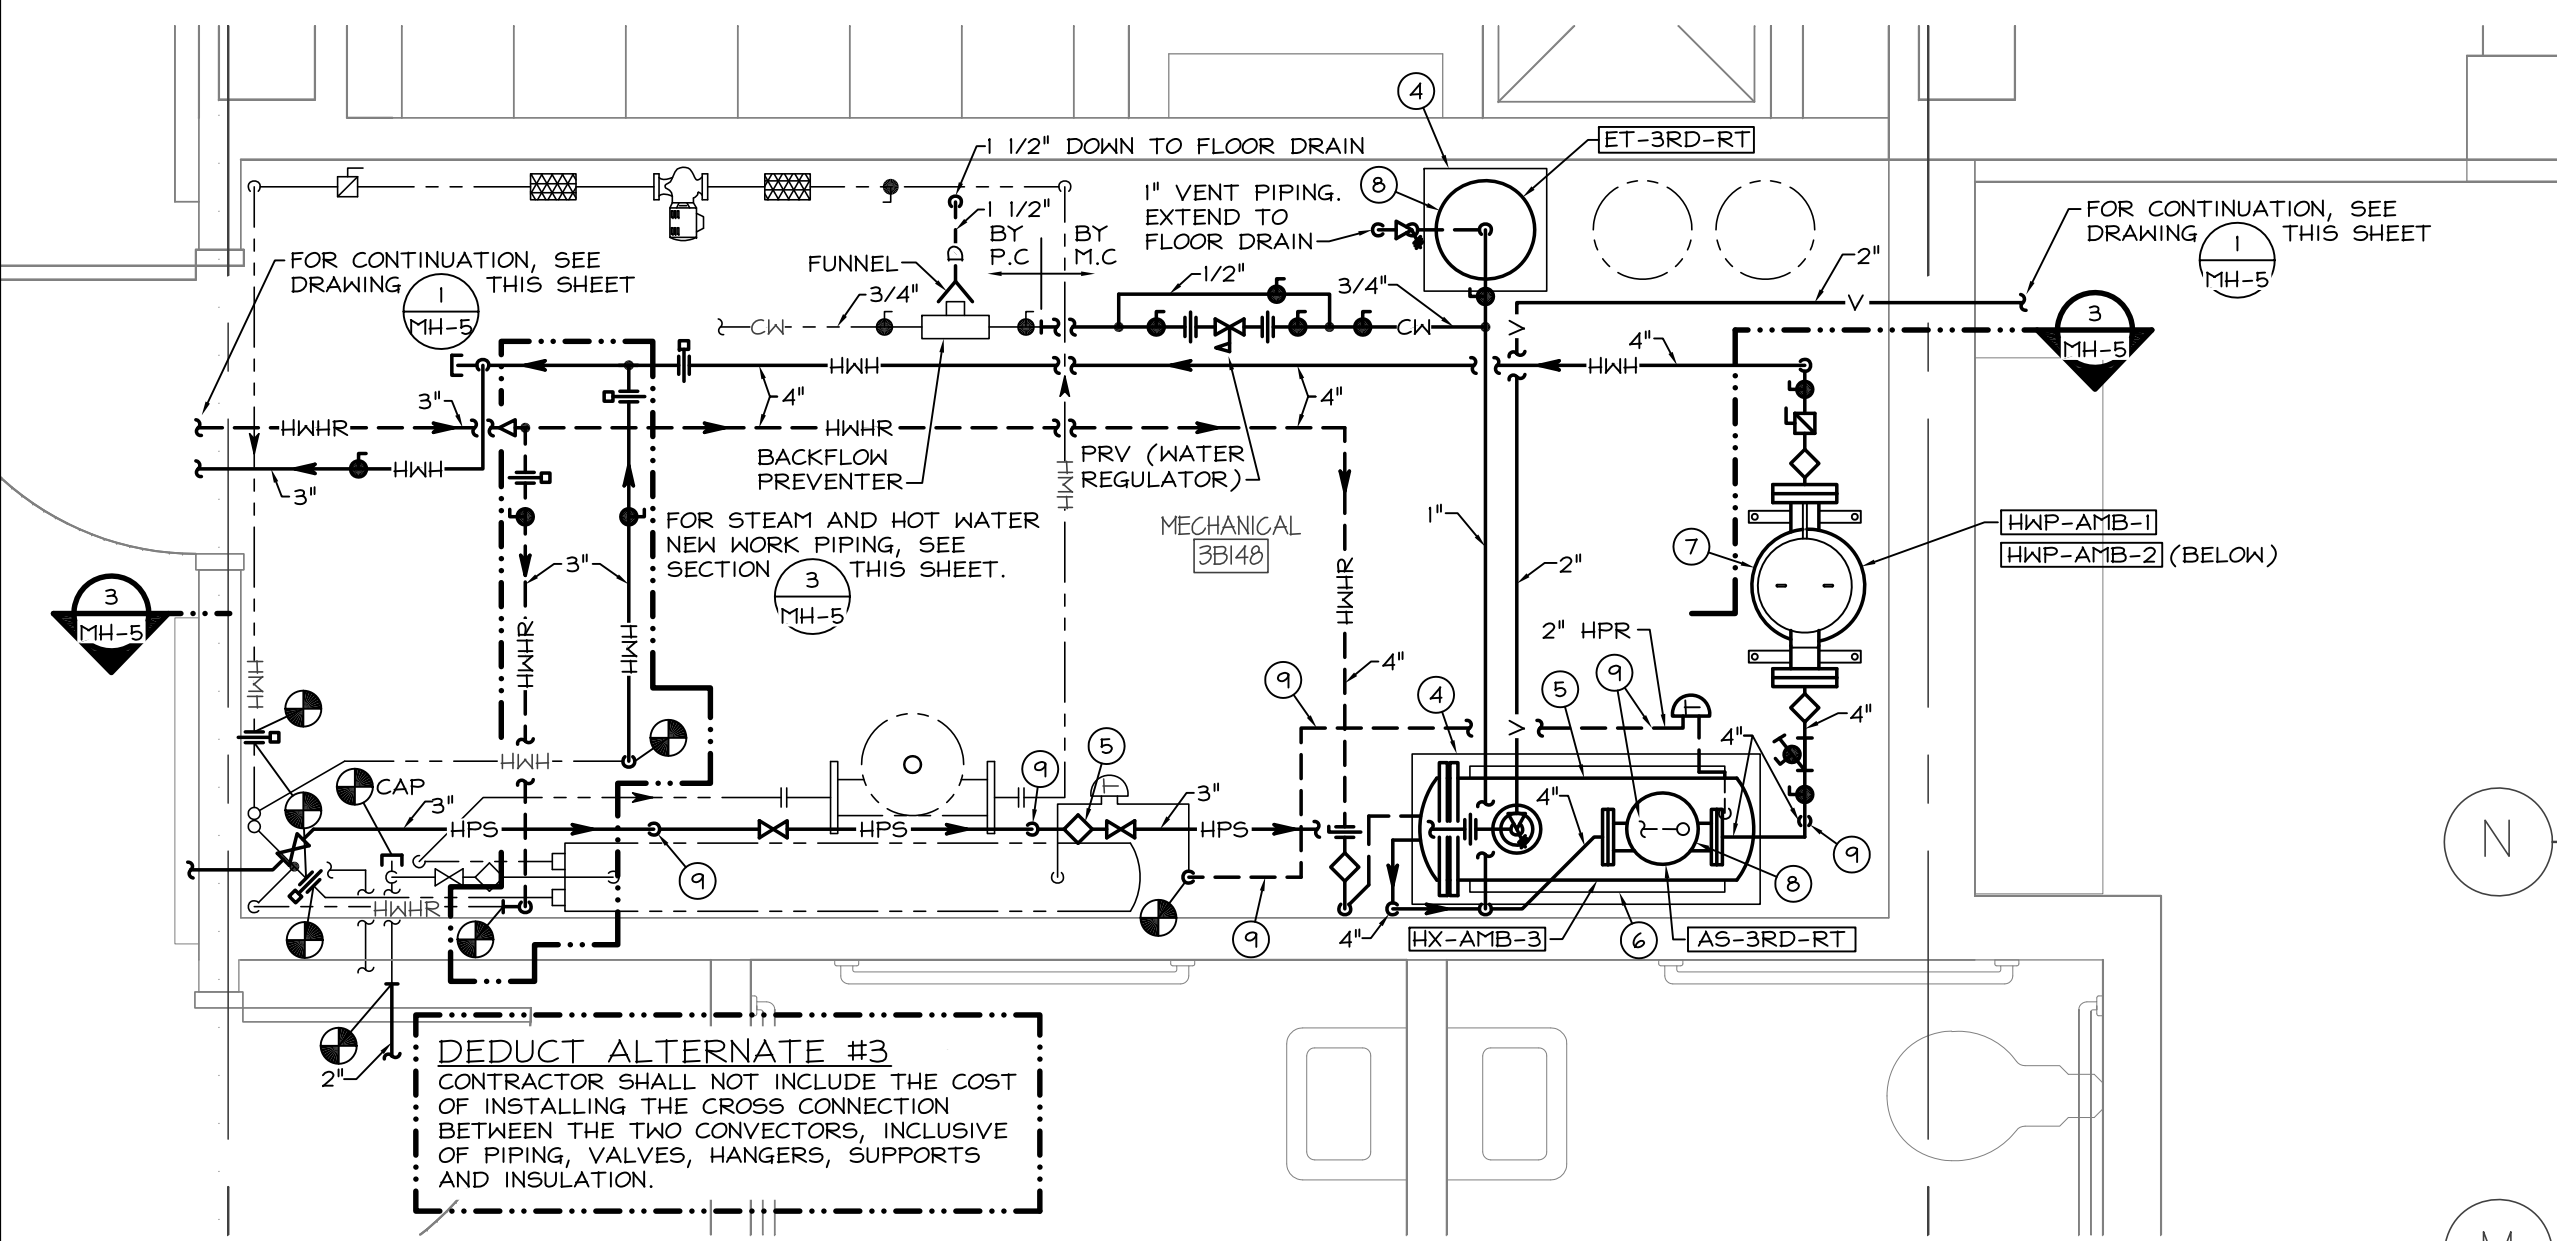- DRAWING NOTES:**
- 1" HWS AND HWHR VALVED AND CAPPED FOR FUTURE USE.
 - FOR RADIANT CEILING PANEL PIPING AND VALVING, SEE DETAIL 14-1.
 - FOR REHEAT TERMINAL PIPING AND VALVING INSTALLATION WITH 3-WAY CONTROL VALVE, SEE DETAIL 14-2.
 - PROVIDE 4" THICK CONCRETE HOUSEKEEPING PAD.
 - STEAM-POWERED HOT WATER CONVERTER. INSULATE ALL PIPING AND CONVERTER SHELL WITH 2" THICK KRAFT-FACED, HIGH-TEMPERATURE FIBERGLASS INSULATION. FOR ALL PIPING, VALVING, TRAP ASSEMBLIES AND STEAM ACCESSORIES, SEE DETAIL 14-3.
 - PROVIDE SUPPORT STAND FOR STEAM CONVERTER.
 - FOR INSTALLATION OF INLINE HOT WATER PUMPS, INCLUDING PIPING, VALVING AND HYDRONIC SPECIALTIES, SEE DETAIL 14-4.
 - FOR CONTINUATION, SEE SECTION 3 THIS SHEET.
 - FOR END OF MAIN DRIP TRAP ASSEMBLY, SEE DETAIL 14-5.
 - 3" LPR, 3/4" MPR, 3" HPS AND 5" CH AND CUR UP TO FOURTH FLOOR ABOVE. FOR CONTINUATION, SEE "FOURTH FLOOR - HVAC NEW WORK" ON DRAWING MH-11.
 - EXISTING MPR RISER.
 - EXISTING 6" LPR RISER.

- GENERAL NOTES:**
- HOT WATER PIPING RUN-OUTS TO REHEAT COILS AND RADIANT CEILING PANELS SHALL BE SIZED AS FOLLOWS:
- | MIN. GPM | MAX. GPM | PIPE SIZE (INCHES) |
|----------|----------|--------------------|
| - | 1.0 | 1/2" |
| 1.1 | 3.0 | 3/4" |
| 3.1 | 5.0 | 1" |
- PITCH ALL PIPING IN DIRECTION OF FLOW.
 - COORDINATE MOUNTING HEIGHT OF THERMOSTATS WITH ELECTRICAL SWITCHES AND ARCHITECTURAL DRAWINGS.
 - ALL REHEAT COILS SHALL BE PROVIDED WITH 2-WAY CONTROL VALVES UNLESS SPECIFICALLY NOTED OTHERWISE. FOR PIPING AND VALVING ARRANGEMENT, SEE DETAIL 14-6.
 - PROVIDE MISCELLANEOUS STEEL REQUIRED TO SUSPEND EQUIPMENT FROM STRUCTURAL STEEL ABOVE. PROVIDE VIBRATION ISOLATION HANGERS WHERE REQUIRED.



3 SECTION - HVAC NEW WORK
1/2" = 1'-0"

REVISIONS	DATE

DEPT. OF VETERANS AFFAIRS
LOUIS A. JOHNSON VAMC
CLARKSBURG, WV 26301

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APPROVED: CHIEF OF STAFF	
APPROVED: VP SURGICAL SPECIALTIES	



DRAWING TITLE THIRD FLOOR - HVAC NEW WORK		PROJECT TITLE MODERNIZE AMBULATORY SURGERY	
PROJECT NO. 540-310	ARCH. PROJECT NO. 09050	DESIGNED BY DDR	DRAWN BY MDN
BUILDING NO.	AUTOCAD FILE NAME 3-VA Clarksburg JHONSON - Ambulatory Surgery Drawings.dwg - 11/15/2010 - MH-5	CHECKED BY CEM	DATE 4/22/2010
LOCATION VAMC CLARKSBURG, WV		DRAWING NO. MH-5	SHEET 40 OF 69

FIRSCHING,
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DEPARTMENT OF VETERANS AFFAIRS



REVISIONS	DATE

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APPROVED: VP SURGICAL SPECIALTIES	

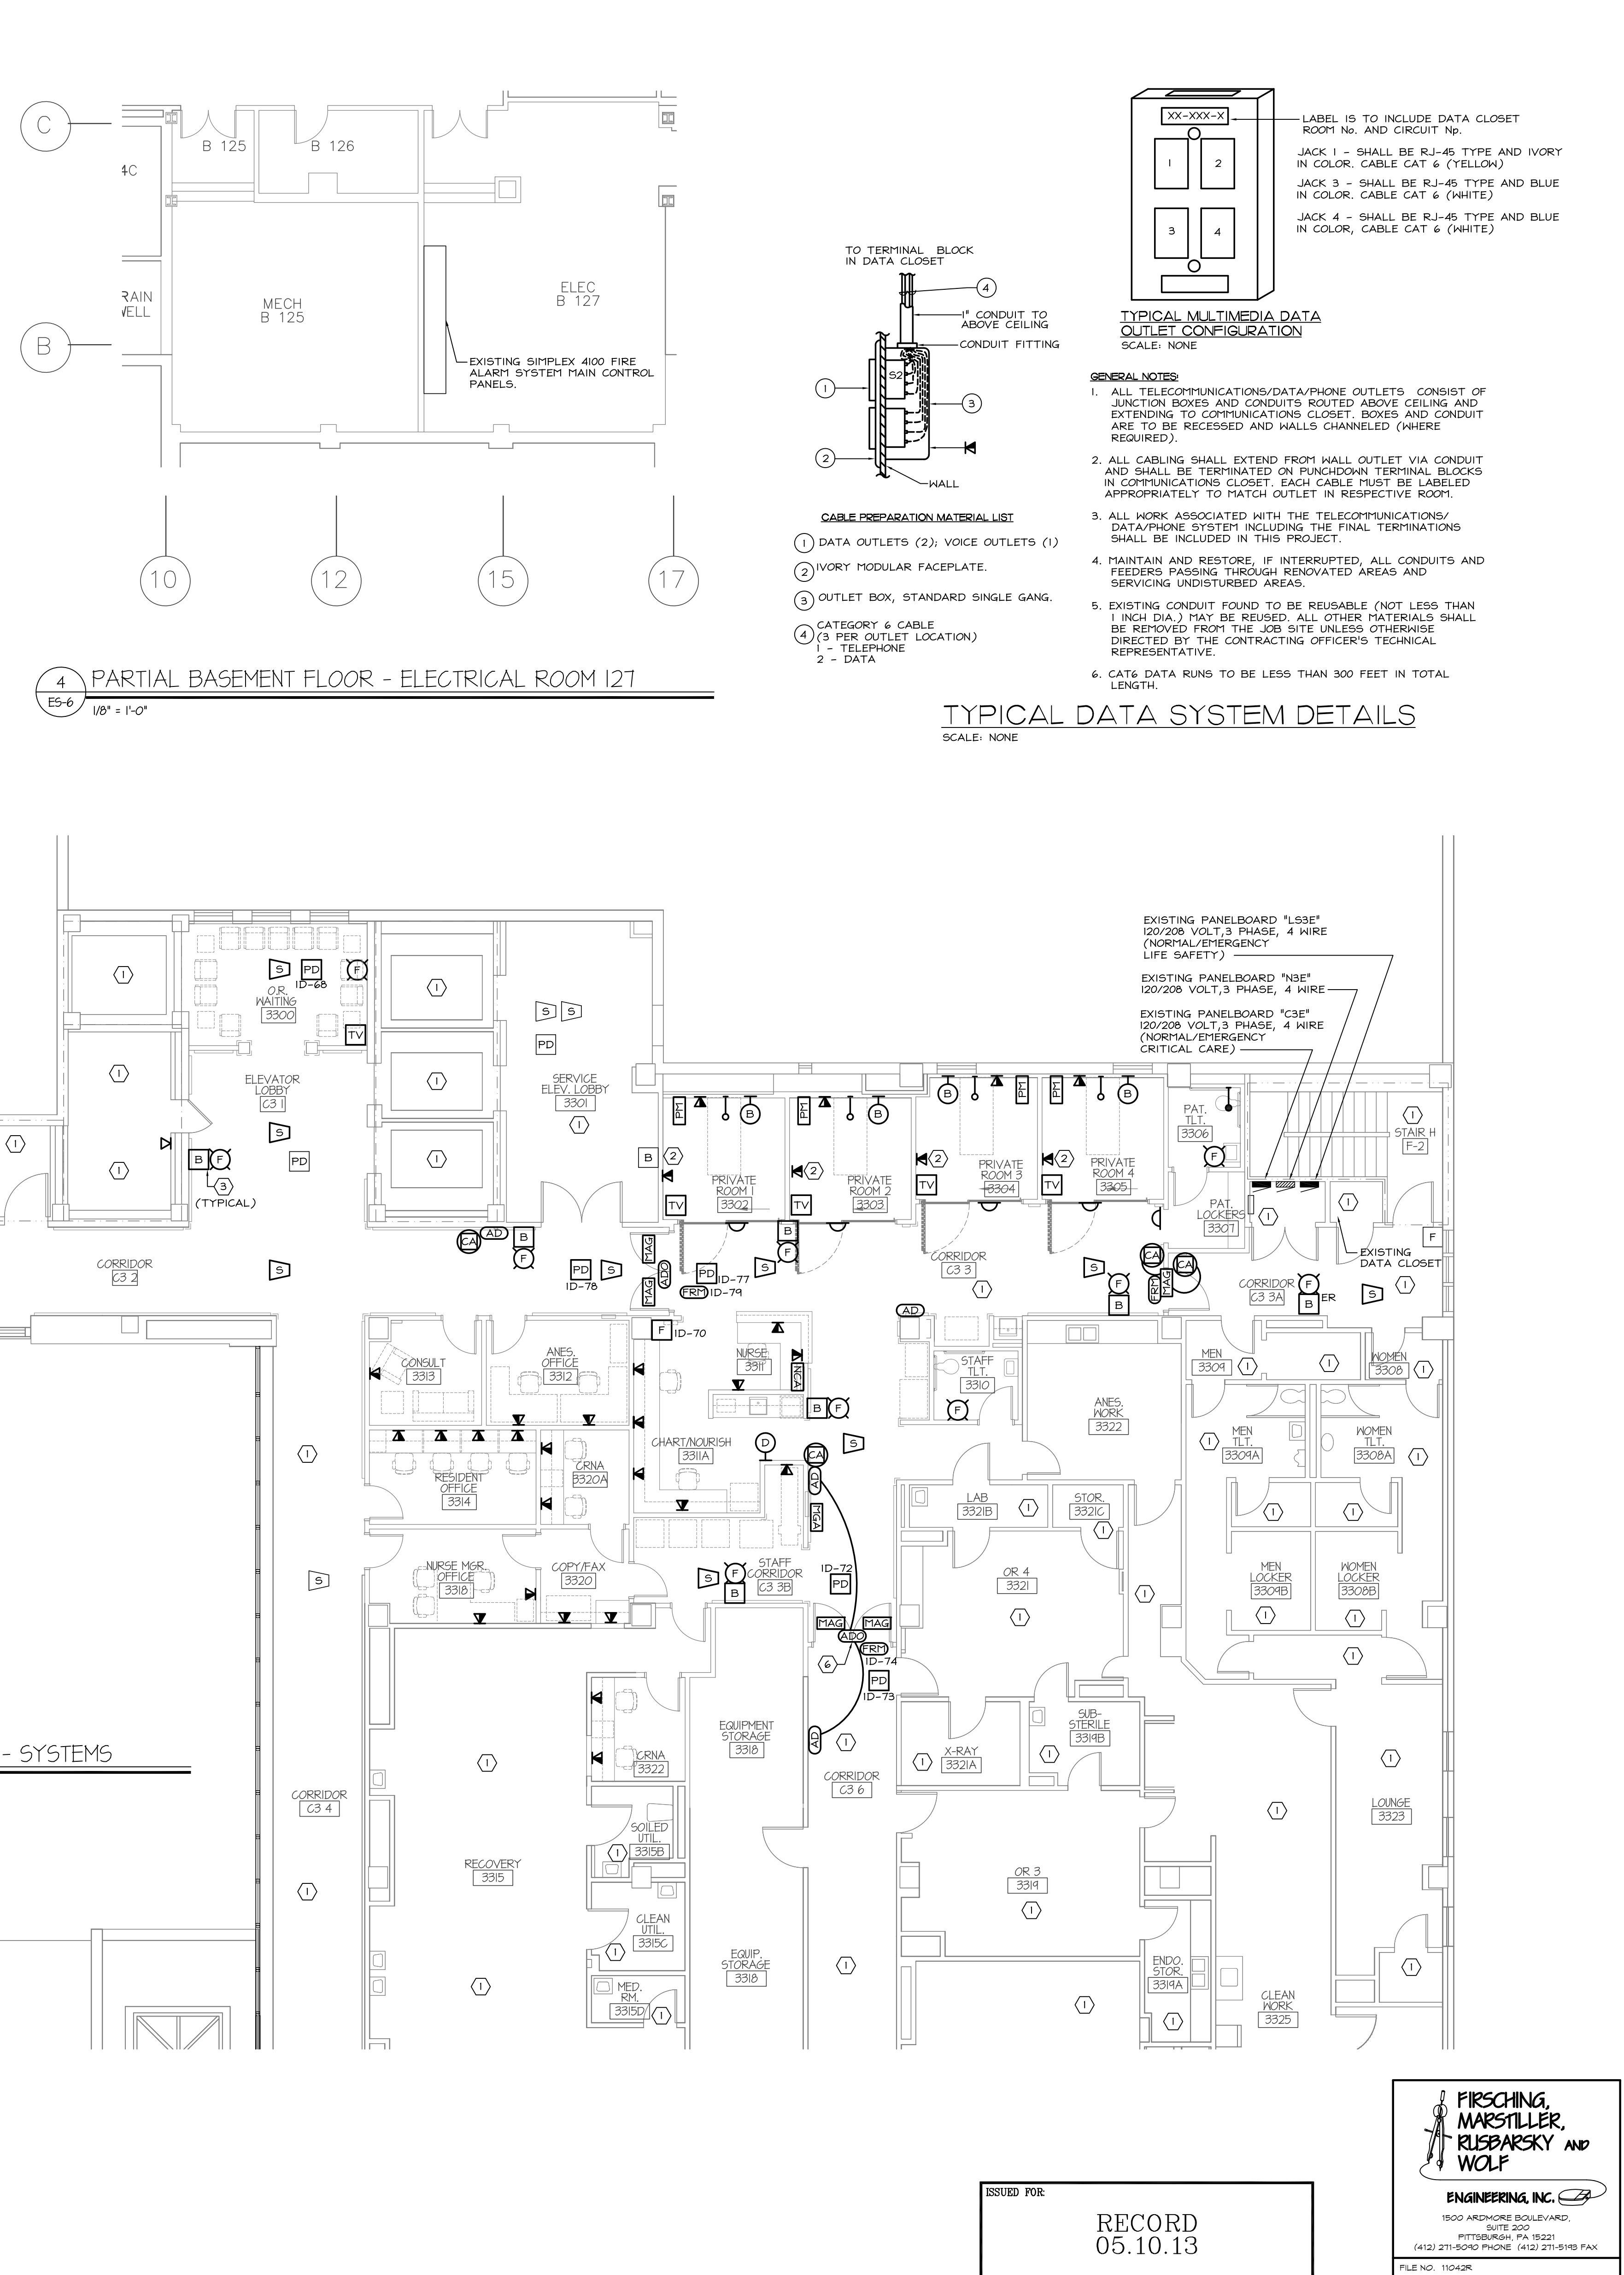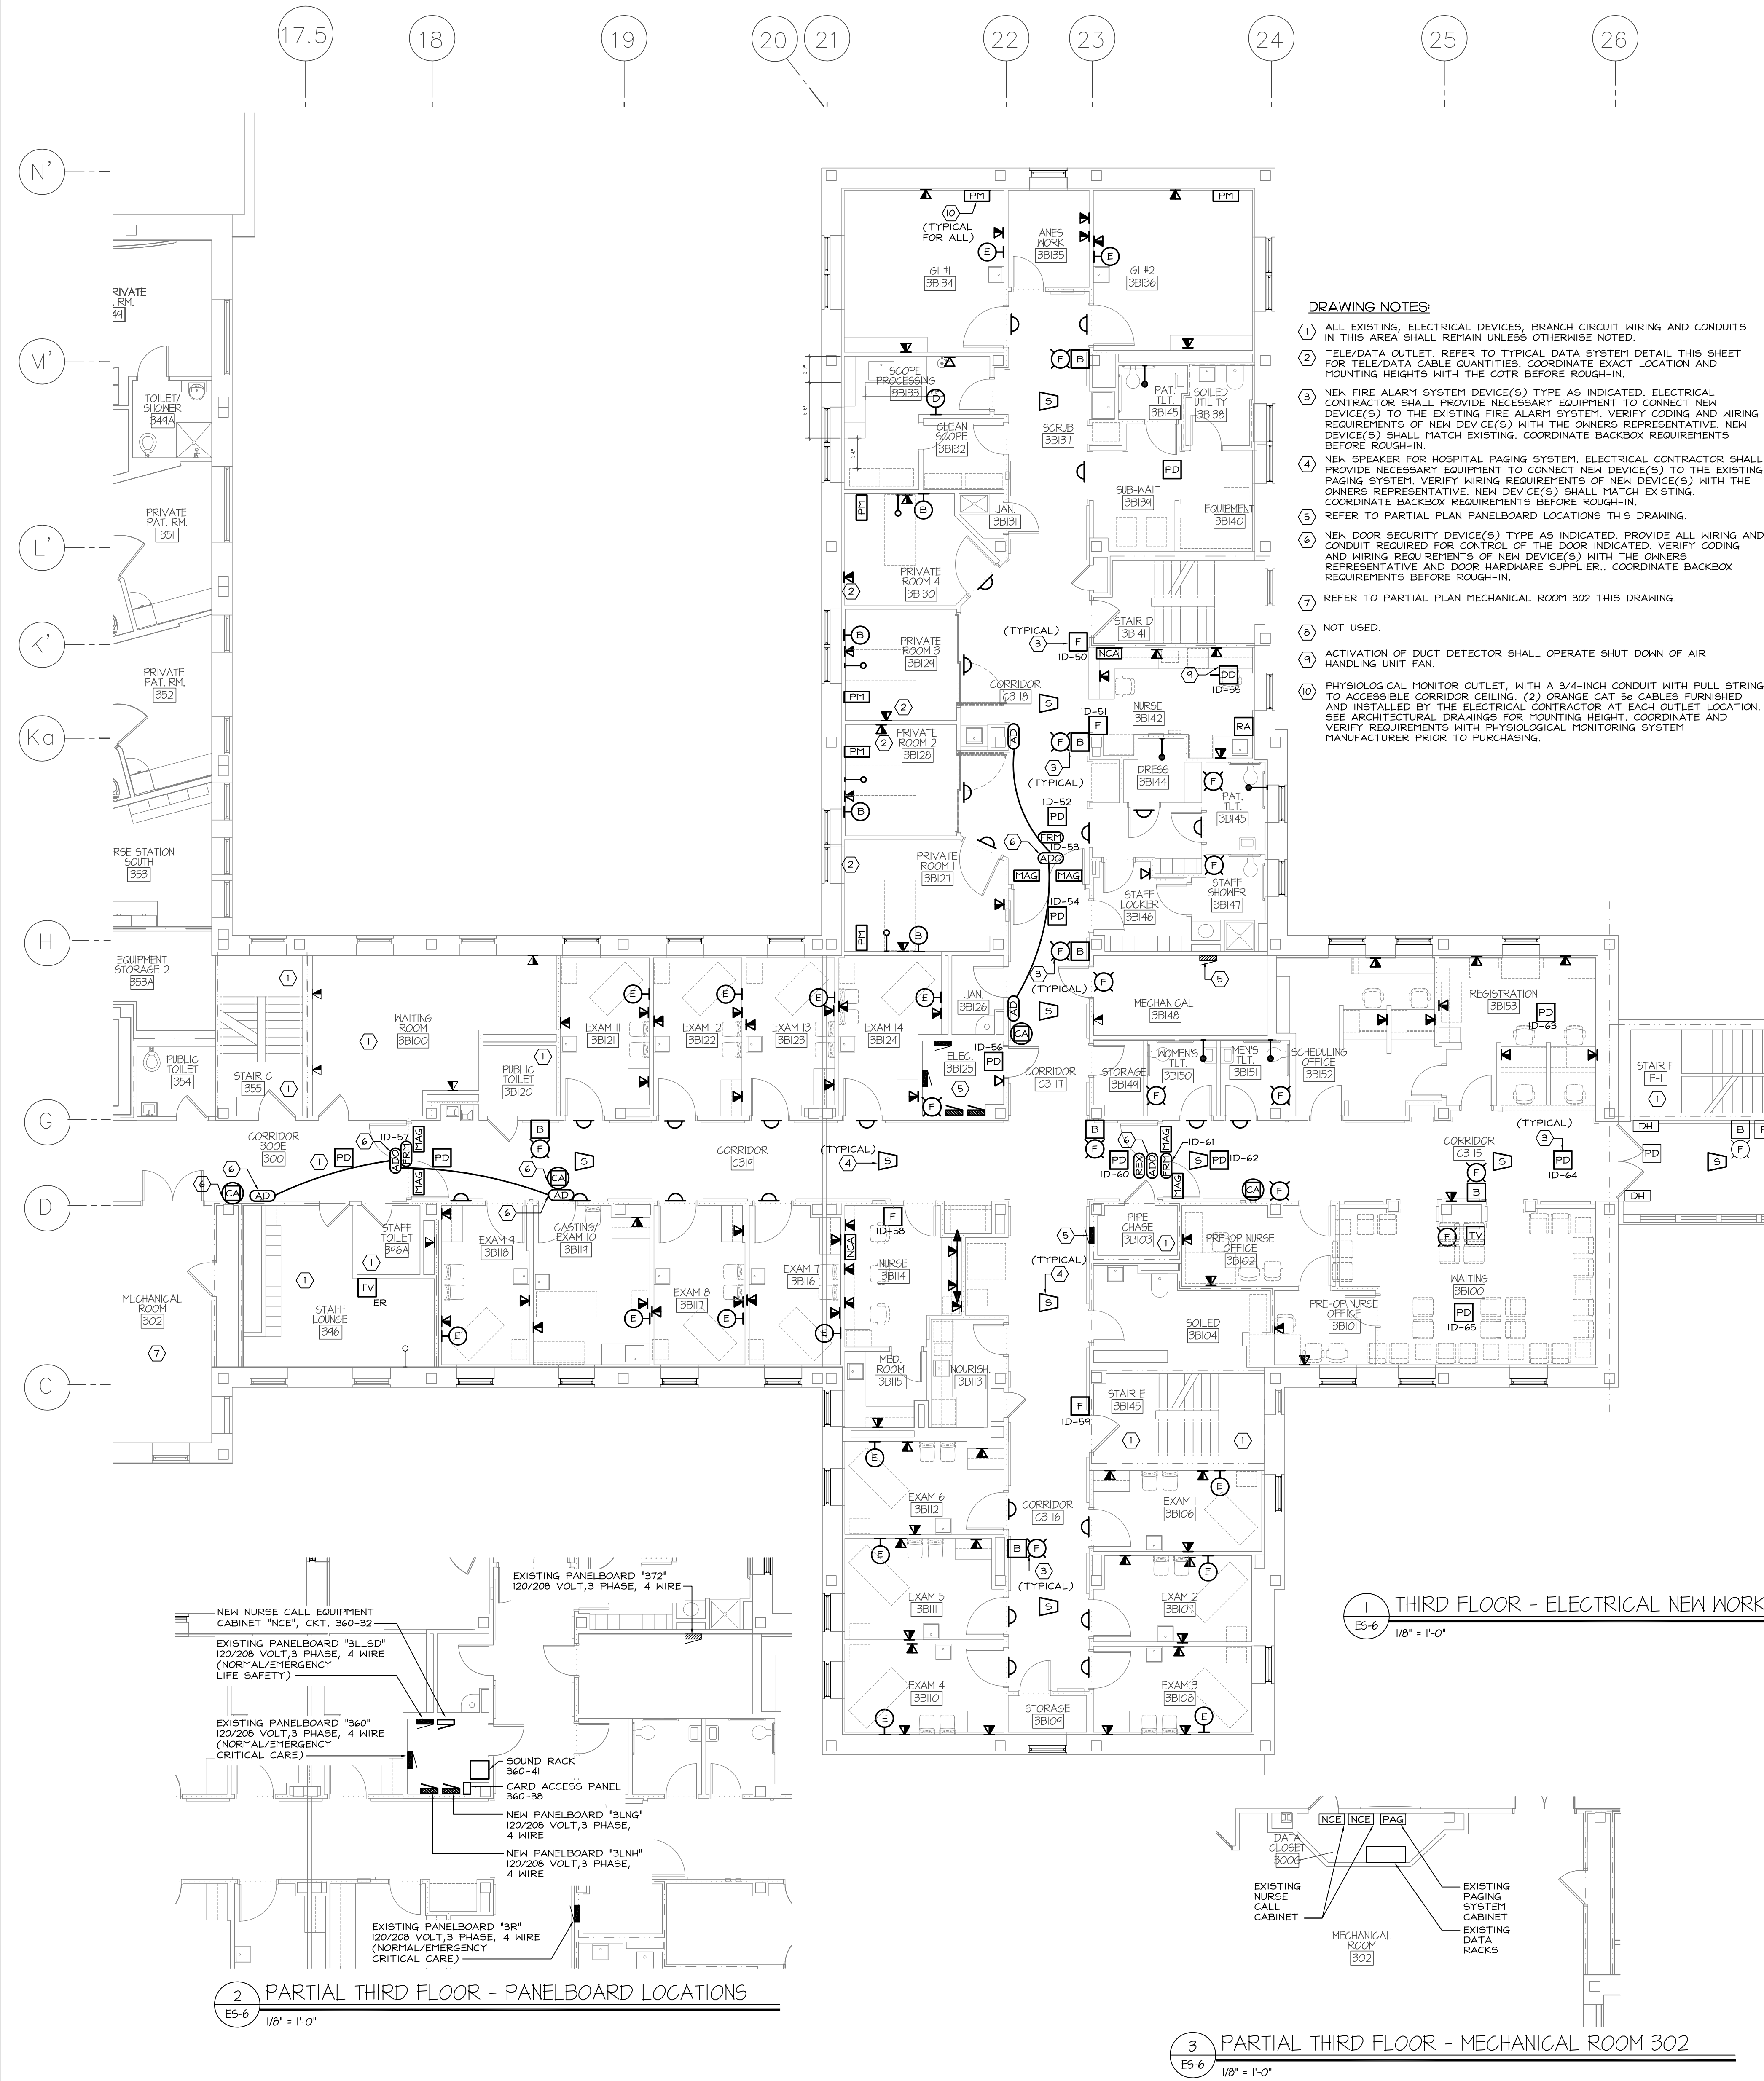PROJECT NO. 540-310	ARCH. PROJECT NO. 09050
BUILDING NO.	AUTOCAD FILE NAME 3.1M Clarksburg J10428 - Modernize Ambulatory Surgery Drawings J10428 - RUC-10428 - R-3

DRAWING TITLE THIRD FLOOR - ELECTRICAL NEW WORK - SYSTEMS		
DESIGNED BY: DLG	DRAWN BY: MRM	CHECKED BY: CEM

PROJECT TITLE MODERNIZE AMBULATORY SURGERY		
LOCATION VAMC CLARKSBURG, WV		

DATE 4/22/2010	DRAWING NO. ES-6
SCALE AS NOTED	SHEET 64 OF 69

DEPARTMENT OF VETERANS AFFAIRS

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